


BOUNDARY	KEY (see boundary drawing)
A	New 500mm High Rendered Conc. Block Wall With new Native Mixed Hedge planted inside.
B	New 1.2m High Bin Store Conc. Block Wall, Rendered on Public Side Only.
C	New 1.8m High Conc. Block Wall, Rendered on Public Side Only.
	New 1.8m High Rendered Conc. Block 'Gossip' Wall (Both Sides).
E	New 1.8m High Concrete Post & Panel Fence.
F	Existing High Concrete Block Wall (To be cleaned and painted)
G	New 800mm High Conc. Block Wall, Rendered on Outer (Public) Side.
H	New 1.8m High Conc. Block Wall, Un-rendered.

,125 x 125mm C
1800 Wide x Concrete Par 300mm high
Note: In situations v is used on gr bottom panel gaps betwee level.
450 x 450 x 4 20/25, as per

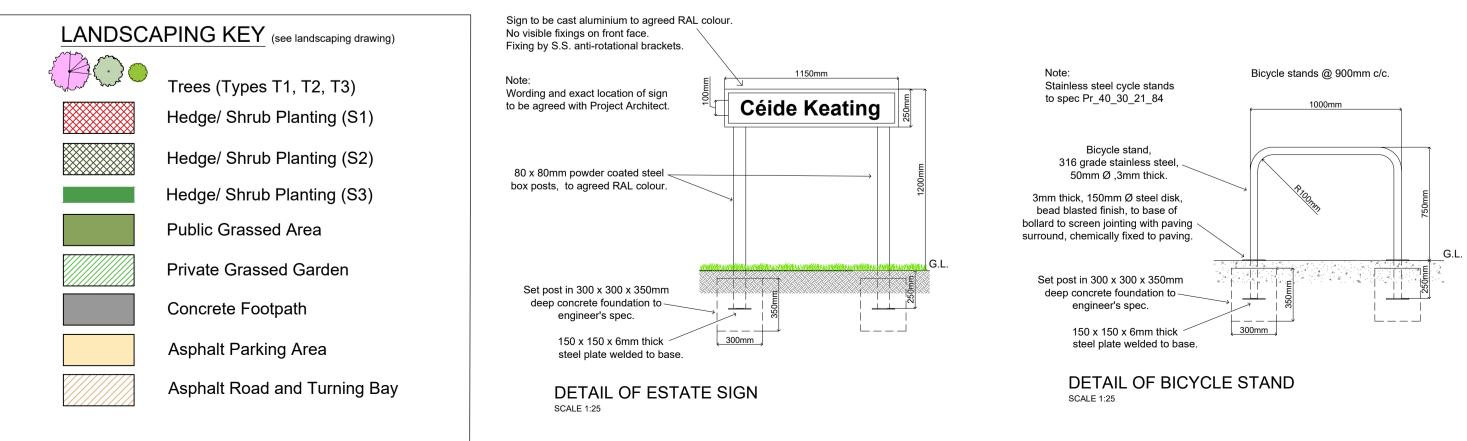

SITE PLAN - LANDSCAPING





Birch - Silver

'Betula pendula'

LAWN AREAS

SHRUB PLANTING (S1)

SHRUB PLANTING (S2)

SHRUB PLANTING (S3)

PROPOSED TREES (T1, T2, T3)

(See Notes)

(See Notes)

(See Notes)

(See Notes)



Ash 'Fraxinus excelsior



'Malus sylvestris'

	Planti	ng Schedule			
Trees					
No	Name	Size	Quantity		
T1	Birch - Silver 'Betula pendula'	14-16cm, root-balled,	3		
T2	Ash 'Fraxinus excelsior'	14-16cm, root-balled, 1.2 – 1.4m clear stem	7		
Т3	Crab Apple ' <i>Malus sylvestris'</i>	10-12cm, bare root, feathered	5		
Hedge Sh	nrub				
S1	Salvia Caradonna; Nepeta Catnip; Lungwort (Pulmonaria spp.)	2lt, pot grown, 20-30cm tall bushy plant	9 per m²		
S2	Guelder Rose Viburnum opulus	2lt, pot grown, 20-30cm tall bushy plant	9 per m ²		
S3	Mixed Native Irish Hedgerow: Hawthorn, Rowan/ Mountain Ash, Hornbeam, Hazel	Bare-root whips, 40-80cm tall bushy plant	Minimum 3-4 plants per m		

PLANTING NOTES:

At the time of planting, the soil shall be moist and friable and not frozen, excessively dry, or water logged.

The excavated hole shall be of sufficient size to accommodate the root-ball and the stock shall be planted so that after any settlement it is the same depth as it was grown in the nursery. The sides and base of the planting pit shall be broken up before planting.

The planting hole shall be backfilled around the plant, the soil shall be lightly firmed to ensure that there is good contact between the root ball and soil substrate.

Water plants once planted.


50mm depth ornamental grade bark mulch, for an area of 1.2mØ, well compacted bark mulch 5-35mm grading as specified.

Irrigation/ aeration pipe with a perforated plastic cap. watering/ liquid fertilising facilitated by means of a perforated plastic pipe (75mmØ) around root ball.

500mm high quality imported top-soil to B.S. 3882:2007.-


> Ground Tree root-ball Existing sub-soil excavated a minimum of 500mm, regarded and prepared for imported

The tree pit should be excavated to allow adequate clearance between the perimeter of the root-ball and the side of the pit. Nominal tee pit size - 1000 x 1000 x 1000mm. Dish shaped as indicated. Fork the bottom and sides of the pit to break up the subsoil, leaving an open textured face.

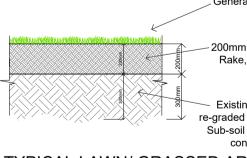

TYPICAL LAWN/ GRASSED AREA DETAIL


Dense Hedge/ Shrub Planting 9 plants per square metre or @ 300mm c/c with staggered rows.

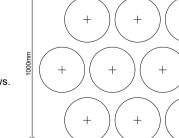

400mm high quality imported top-soil to B.S. 3882:2015. Rake, grade & level entire area & grass as specified.

100mm clean stone drainage layer

Existing sub-soil excavated a minimum of 200mm, re-graded and prepared for imported top-soil as specified. Sub-soil to be free draining, free from rubbish, building contamination, large stones/ rocks >150mm.

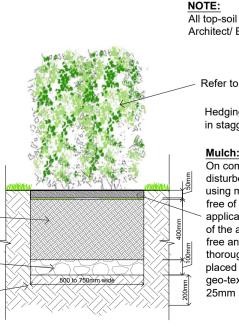

TYPICAL HEDGING/ SHRUB DETAIL SCALE 1:25

All trees to be planted into topsoil pits with a depth of 800mm x 800mm wide (See Notes) PLANTING SPECIFICATION All topsoil shall to subject to inspection and approval of the Landscape Architect before being spread Topsoil shall confirm to BS.3882, parts 1-5 and shall be free draining sandy loam. Topsoil shall be free of stones over 40mm in diameter and stones over 10mm shall

All lawn areas to have a soil depth of 200mm of good quality topsoil

All shrub areas to have a soil depth of 400mm of good quality topsoil

All shrub areas to have a soil depth of 450mm of good quality topsoil

All shrub areas to have a soil depth of 450mm of good quality topsoil

not exceed 5% by weight. Topsoil shall be free from subsoil, sods, sharps, plastics and non-soil forming materials and shall not carry known plant or animal diseases. Soils from woodland, heath, bog or contaminated lands shall not be used. Topsoil shall be friable, well aerated and with a good crumb structure. Topsoil shall not be obtained from a site subject to water logging. Topsoil shall be free from persistent weeds, including docks, nettles, thistles, ragworth, Japanese Knotweed, spear thistle, Himalayan Balsam, Giant Hogweed and Couch Grass. The contractor shall verify in writing the location and type of source used in supplying topsoil.

Proposed lawns A 200mm layer of imported topsoil to be spread over the entire surface. Soil levels to be raised with a suitable layer of subsoil no less than 300mm deep below finished topsoil layer. Topsoil to be cultivated to a fine tilth, graded and raked of any stone and debris greater than 50mm and disposed of to a licensed disposal site. Where there is an extended period before seeding soil should be treated with a herbicide to remove existing weeds prior to cultivation. Grass seed growing rates shall be according to seed supplier's recommendations and approved by the Landscape Architect. Seeding shall be carried out in two equal traverse passes. The seed shall be lightly raked manually on small areas. Or larger areas, the seed shall be mechanically sown with a seeder so that it is lightly harrowed and rolled in situ. Grass seed mix shall be an amenity no. 2 lawn seed mix. Soil level to lie flush with top of surrounding kerbs, footpaths and service covers. Soil should be spread in such a way that settling will not occur after job is complete.

Extra heavy standard trees to be planted in 1.0m x 1.0m x 1.0m tree pits and backfilled with topsoil and slow-release fertiliser to manufacturers recommended rates. See tree planting support details. Root-balled trees shall comply with sections 1 & 2 of BS 4043:1989, Recommendations for transplanting root-balled trees as well as BS 3936: 1993, Nursery stock, part 1, specification for trees and shrubs. All trees to be watered-in thoroughly once planted. Root-balled trees to be lifted from nursery during dormant season only. Trees with a girth size between 12-16cm to be double staked and supported with a timber cross bar as illustrated. Trees with a girth between 10-12cm shall be single staked and supported with a rubber strap and rubber collar. Soil level around base of trees to be same depth as in nursery.


Proposed planting areas


A 450mm layer of topsoil to be spread over all proposed shrub planting beds. A 450mm deep x 750mm wide trench to be dug and backfilled with good quality topsoil for all proposed hedge planting areas. See topsoil specification above. See Topsoil specification above for more details. All soil levels are to be flush with top of surrounding footpaths, kerbs and service covers. Ensure soil does not drop below these levels once settling has occurred. See plant schedule for list of plants and specifications. All tree, hedging and shrub locations are indicated on drawing. Slow-release fertiliser to be spread over all planting areas to manufacturers recommended rates. Mulching All beds where Hydrangea shrubs, Berberis shrubs and Prunus lusitanica hedging is planted shall be covered with a 50mm layer of dry composted manure from Gee-Up, Blarney, Co.Cork or equivalent.

Ss_45_35_45_35 Grass Seeding Systems (Green Areas and Wildflower Meadows) Spray off all areas to be grass seeded. Final grade to achieve flowing contours. Remove all

stones to all seeded areas to produce a fine tilth for grass seed. Topsoil will usually be supplied from the original surface layer of grassland or cultivated land in the area or be imported for use on the site, it shall conform to the description of topsoil set out in British Standard Specification No.3882: 1965. A minimum of 200mm topsoil for grass. All surface cultivations for the purpose of producing a tilth shall be carried out under suitable soil and weather conditions. Stockpiled topsoil to be spread graded, and to levels over the prepared formation to form lawns, terraces and embankments as per Architect's drawings.


Grass seed mixture comprised of the following mixture: 60% Perennial Rye Grass; 20% Chewing Fescue, 20% Slender Creeping Red Fescue. Pre-germination fertiliser is to be incorporated into topsoil prior to seeding at a rate of 180g/m2. A fertiliser of minimum composition 10% nitrogen, 15% phosphoric acid and 10% potash is required.

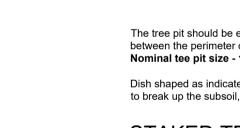

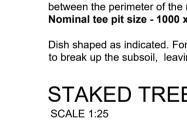

NOTE

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DR-CCC-A-WD-123

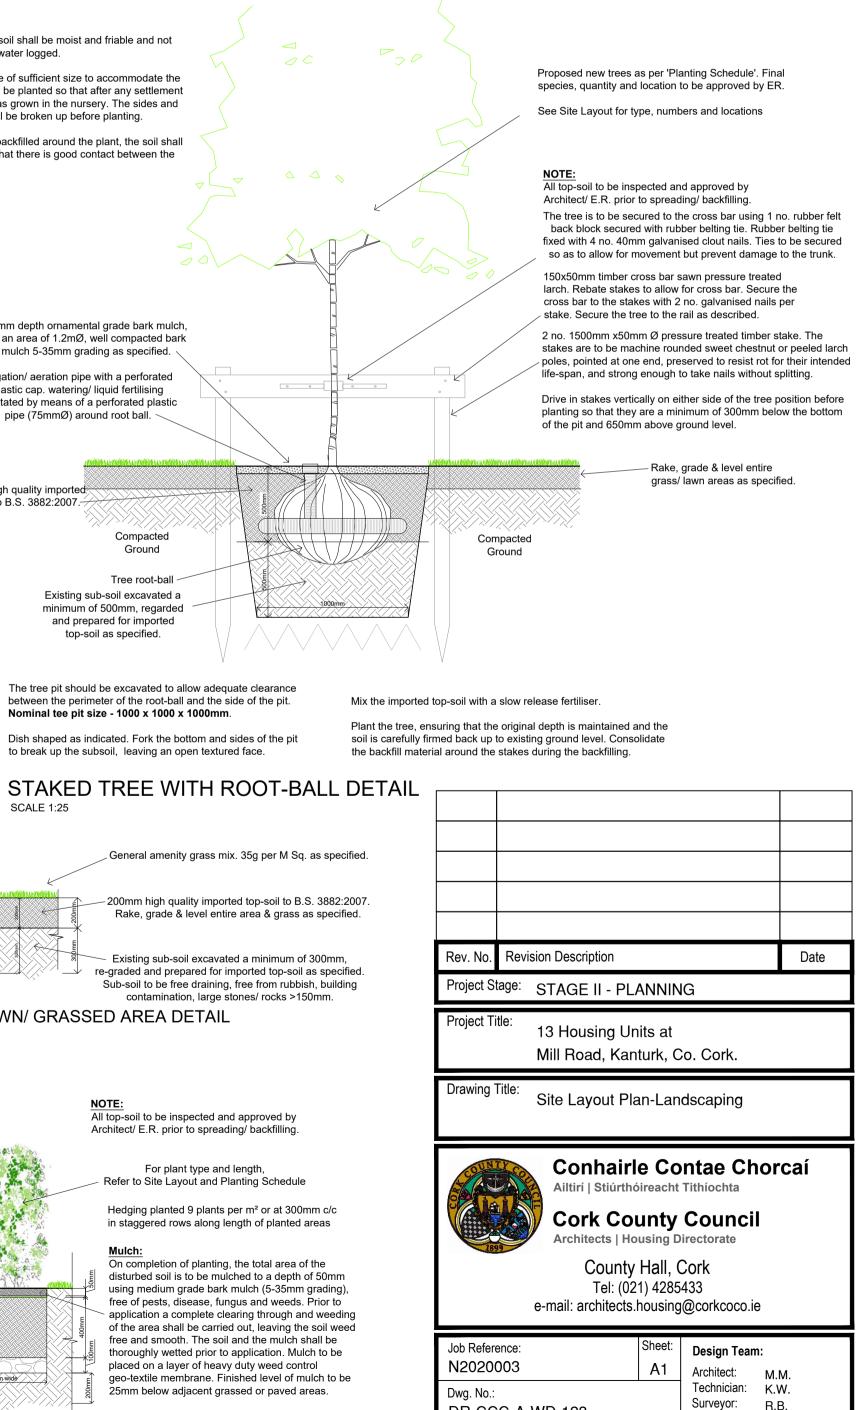Scale:

July '23 | 1:25


Date:

Issue for:

Planning

Snr. Architect: R. Henry

Rialtas na hÉireann Government of Ireland

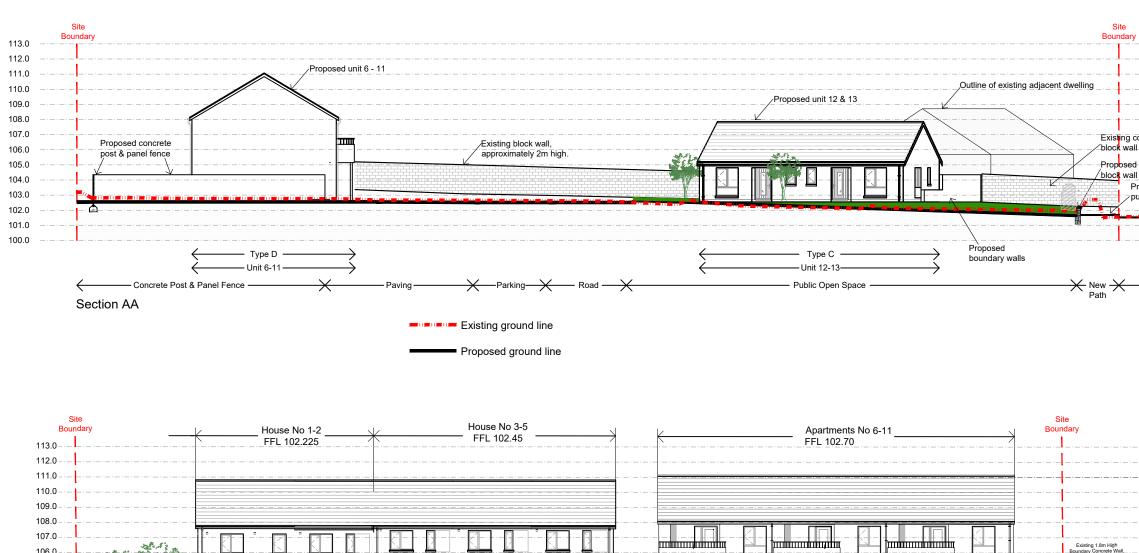

Section BB - Street Elevation

106.0 -

105.0 -


104.0 -

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Section EE - Thru' House No.13

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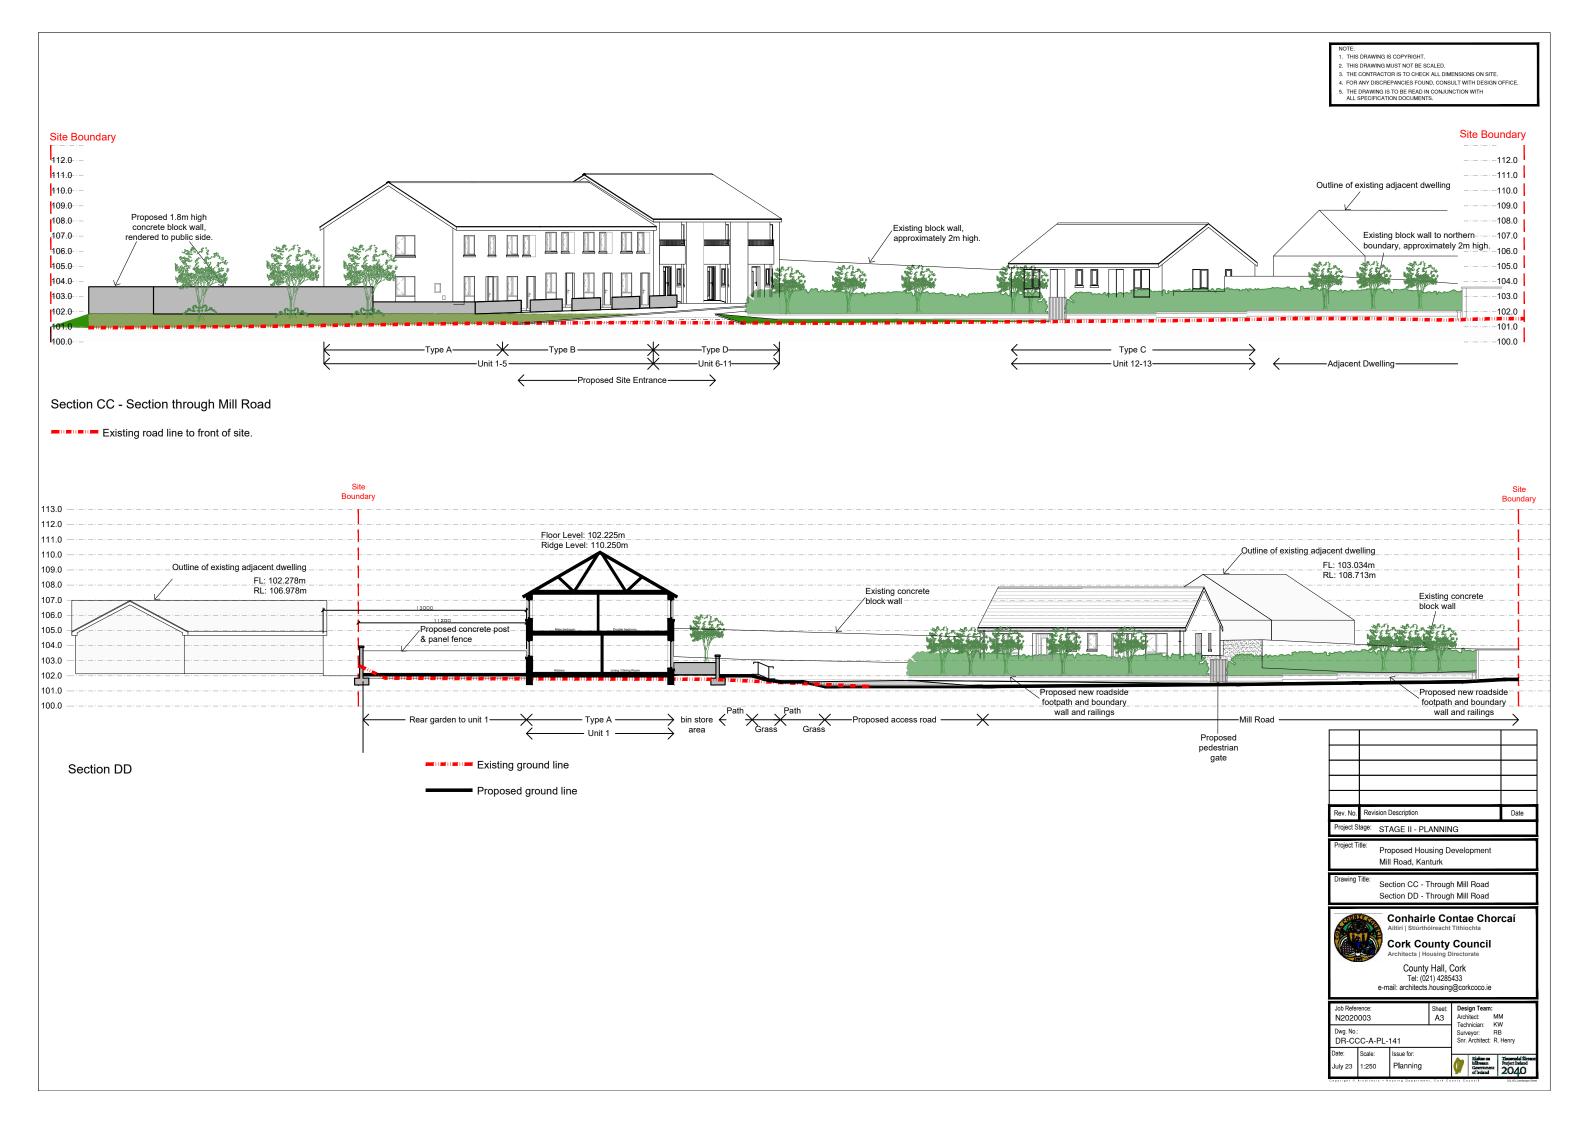
- 113.0 112.0 _111.0 -110.0 - 109.0 108.0 107.0 - 106.0 105.0 _104.0 _ 103.0 - 102.0 - 101.0


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Rev. No.	Revision [Date							
Project S	tage: ST.	AGE II - PL	ANNIN	IG							
Project Title: Proposed Housing Development Mill Road, Kanturk											
Drawing Title: Section AA - Through Mill Road Section BB - Through Mill Road											
	50		Conhairle Contae Chorca Alittiri stiürthöireacht Tithiochta Cork County Council								
		Conhairl Ailtirí Stiúrtho Cork Co	le Co ^{óireacht} unty	nta Tithío	e Cho ^{chta} uncil	oro	caí				
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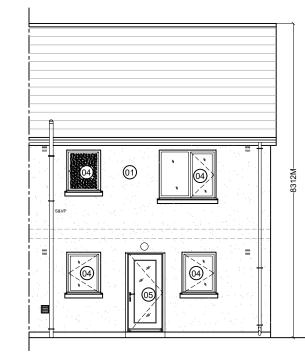
Existing —
 Public Road

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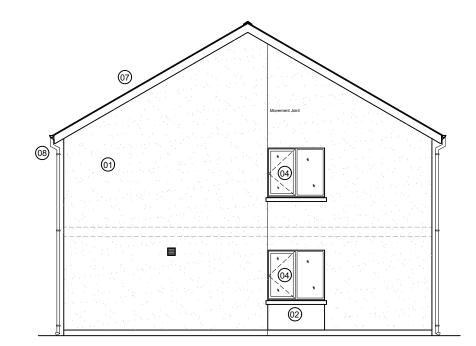


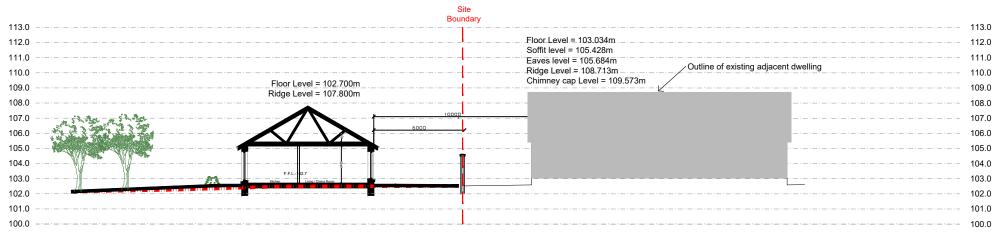

Front Elevation

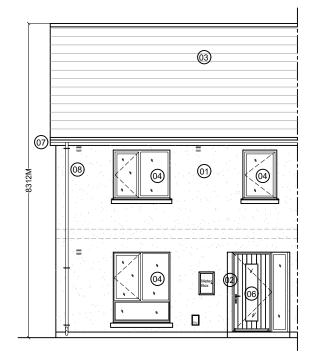


Rear Elevation




Side Elevation - End of Terrace - No.1



Ground Floor Plan - 51.4m² House Type A 3 Bed End of Terrace (No.1)

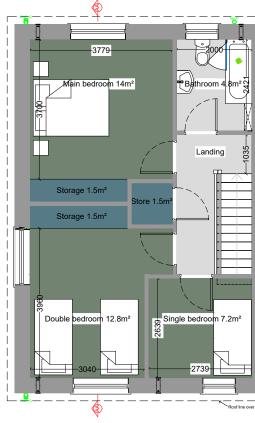

First Floor Plan - 50.2m²

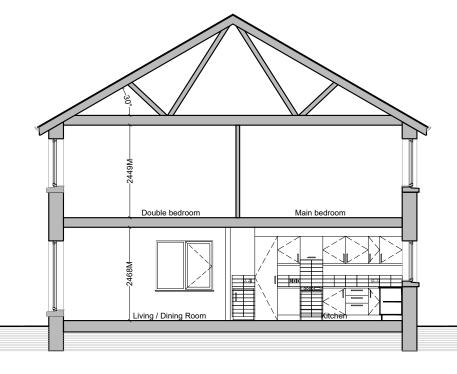

Section AA

	TARGET GROSS FLOOR AREA	MINIMUM MAIN LIVING ROOM AREA	AGGREGATE LIVING AREA	AGGREGATE BEDROOM AREA	STORAGE AREA
	(M ²)	(M ²)	(M ²)	(M ²)	(M ²)
3 BED/ 5P HOUSE (2 STOREY)	92.0	13	34	32	5
Proposed 3 BED (Type A)	101.6	16	37.3	34	6.2


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LEGEND:

01: Wet-dash render finish to selected colour


- 02: Smooth render finish to selected colour
- 03: Fibre cement slate, blue-black in colour
- 04: Dark uPVC windows to selected colour
- 05: Dark uPVC door/ window set to selected colour
- 06: Composite engineered door with a hardwood finish to selected colour
- 07: Dark uPVC fascia to selected colour
- 08: Dark uPVC rainwater goods to selected colour


		Description			Date		
Project S	^{tage:} ST	AGE II - PL	ANNIN	IG			
Project Ti	Pr	oposed Hou II Road, Kar	0	evelopment			
Drawing Title: House Type A - 3 Bed End of Terrace Plans, Elevations & Section							
Altiri Stlürthöireacht Tithiochta Conhairle Contae Chorcaí Altiri Stlürthöireacht Tithiochta Cork County Council Architects Housing Directorate County Hall, Cork Tel: (021) 4285433 e-mail: architects.housing@corkcoco.ie							
	5	Conhairl Ailtirí Stiúrtho Cork Co Architects Ho County Tel: (02	e Co bireacht unty busing D Hall, (21) 4285	Tithiochta Tithiochta Council Virectorate Cork 433	rcaí		
Job Refer N20200	e-n ence: 003	Conhairl Ailtirí Stiúrtho Cork Co Architects Ho County Tel: (02	e Co bireacht unty busing D Hall, (21) 4285	ntae Chor Tithiochta Council irectorate Cork 433 @corkcoco.ie Design Team: Architect: Mil Technican: KV	VI VI		
N2020 Dwg. No.:	e-n ence: 003	Conhairl Ailtirí Stiúrth Cork Co Architects Ho County Tel: (02 nail: architects.	e Co óireacht unty busing D Hall, (11) 4285 housing Sheet:	ntae Chor Tithiochta Council Virectorate Cork 433 @corkcoco.ie Design Team: Architect: MI	M V 3		

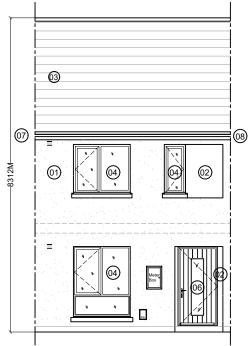


Front Elevation


House Type B - 87m² 2 Bed Terrace Mid Terrace (No.2 to 5)

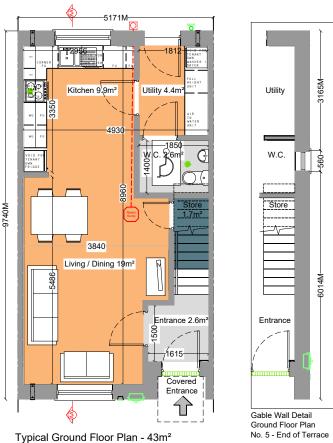


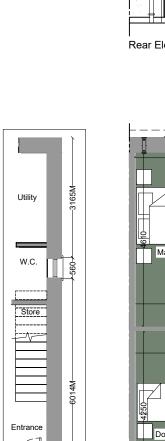


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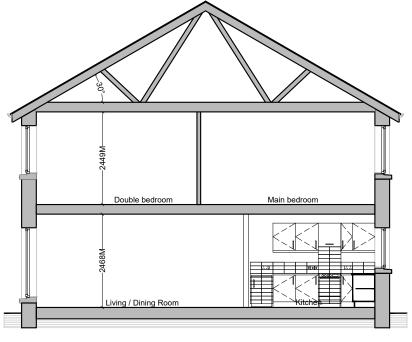


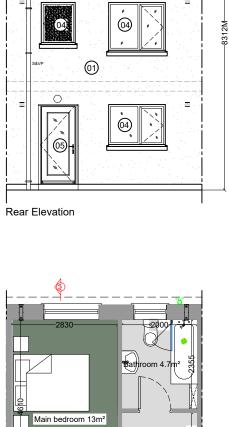

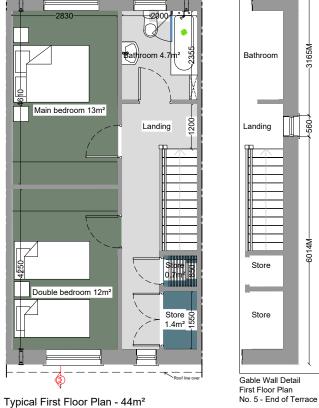

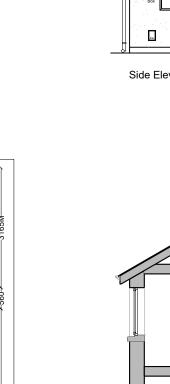

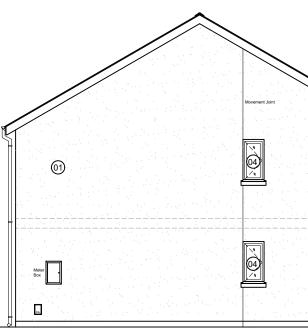Side Elevation - End of Terrace - No.5




Section AA

House Type B - 87m² 2 Bed Terrace Mid Terrace (No.2 to 5)

	TARGET GROSS FLOOR AREA	MINIMUM MAIN LIVING ROOM AREA	AGGREGATE LIVING AREA	AGGREGATE BEDROOM AREA	STORAGE AREA
	(M ²)	(M ²)	(M ²)	(M ²)	(M²)
2 BED/ 4P HOUSE (2 STOREY)	80.0	13	30	25	4
Proposed 2 BED (Type B)	87	19	33	25	3.8

Gable Wall Detail

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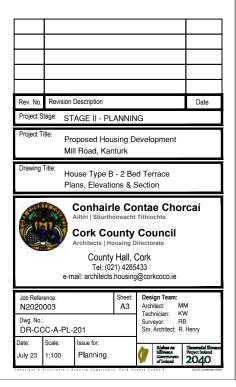


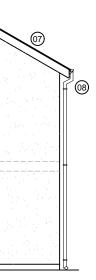LEGEND:

- 01: Wet-dash render finish to selected colour
- 02: Smooth render finish to selected colour
- 03: Fibre cement slate, blue-black in colour
- 04: Dark uPVC windows to selected colour
- 05: Dark uPVC door/ window set to selected colour

06: Composite engineered door with a hardwood finish to selected colour

- 07: Dark uPVC fascia to selected colour
- 08: Dark uPVC rainwater goods to selected colour





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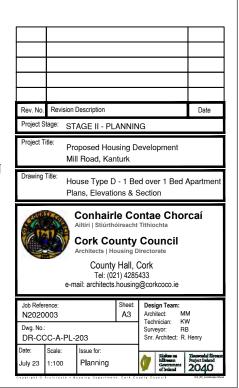
Ground Floor Unit No.'s: 7, 9 & 11	TARGET GROSS FLOOR AREA	MINIMUM MAIN LIVING ROOM AREA	AGGREGATE LIVING AREA	AGGREGATE BEDROOM AREA	STORAGE AREA
	(M ²)	(M ²)	(M ²)	(M ²)	(M ²)
1 BED/ 2P APARTMENT Guidelines	45.0	11	23	11	3
1 BED (Type D) - Kanturk Proposed	57	18.5	25.7	13.0	2.9

First Floor Unit No.'s: 6, 8 & 10	TARGET MINIMUM GROSS MAIN LIVING FLOOR AREA ROOM AREA		AGGREGATE LIVING AREA	AGGREGATE BEDROOM AREA	STORAGE AREA
	(M ²)	(M ²)	(M ²)	(M ²)	(M ²)
1 BED/ 2P APARTMENT Guidelines	45.0	11	23	11	3
1 BED (Type D) - Kanturk Proposed	52.0	16.3	24.2	11.8	3.3

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LEGEND:

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- 05: Dark uPVC door/ window set to selected colour
- 06: Composite engineered door with a hardwood finish to selected colour
- 07: Dark uPVC fascia to selected colour
- 08: Dark uPVC rainwater goods to selected colour



Template reference: 2.1 Document Issue Register DRAWING ISSUE F	DRAWING ISSUE REGISTER			Cork Cour Architects County Ha	s- Hou	sing D	irecto	rate,	CORT							
Project Number: N2020003			Project Ar	chitect	:		MM									
Project Title:				Project Te	chnicia	in:		кw								
Project Stage:	Stage II			Project Q.	S. :			RB								
Purpose of Issue					Issued by	INT	INT	INT	INT	INT	INT	INT	INT	INT	INT	
Work in Progress (WIP)	Pa	art 8	Х		Day	05										
Co-ordination	Co	osting			Month	07										
Information	Te	ender			Year	2023										
Review & Comments	Co	onstruction			Format	pdf										
Approval	A	s Built			Insert pdf, Acad, Model or Paper above											
Distribution																
Company:																
Design Team																
Main Contractor																
Department of Housing, Planning	g and Loo	al Governent														

Drawing No.	Drawing Title	Scale	Sheet	Revision				
N2020003 DR-CCC-A-PL-100	Existing Site Location Map	1:2500	A3	✓				
N2020003 DR-CCC-A-PL-101	Existing Site Location Map	1:1000	A3	✓				
N2020003 DR-CCC-A-PL-111	Site Demolition Plan	1:500	A3	✓				
N2020003 DR-CCC-A-PL-121	Site Plan	1:250	A1	✓				
N2020003 DR-CCC-A-PL-122	Site Plan-Boundaries	1:250	A1	✓				
N2020003 DR-CCC-A-PL-123	Site Plan-Landscaping	1:250	A1	✓				
N2020003 DR-CCC-A-PL-140	Proposed Site Section A+B+E	1:250	A3	✓				
N2020003 DR-CCC-A-PL-141	Proposed Site Section C+D	1:250	A3	✓				
N2020003 DR-CCC-A-PL-200	House Type A	1:100	A3	✓				
N2020003 DR-CCC-A-PL-201	House Type B	1:100	A3	✓				
N2020003 DR-CCC-A-PL-202	House Type C	1:100	A3	✓				
N2020003 DR-CCC-A-PL-203	House Type D	1:100	A3	✓				