ISSUE SLIP

PROJECT : Residential Development, Broomfield

PROJECT NO: 24026

SHEET NO: CAD filena List of drawing registers for **n/a** this project:


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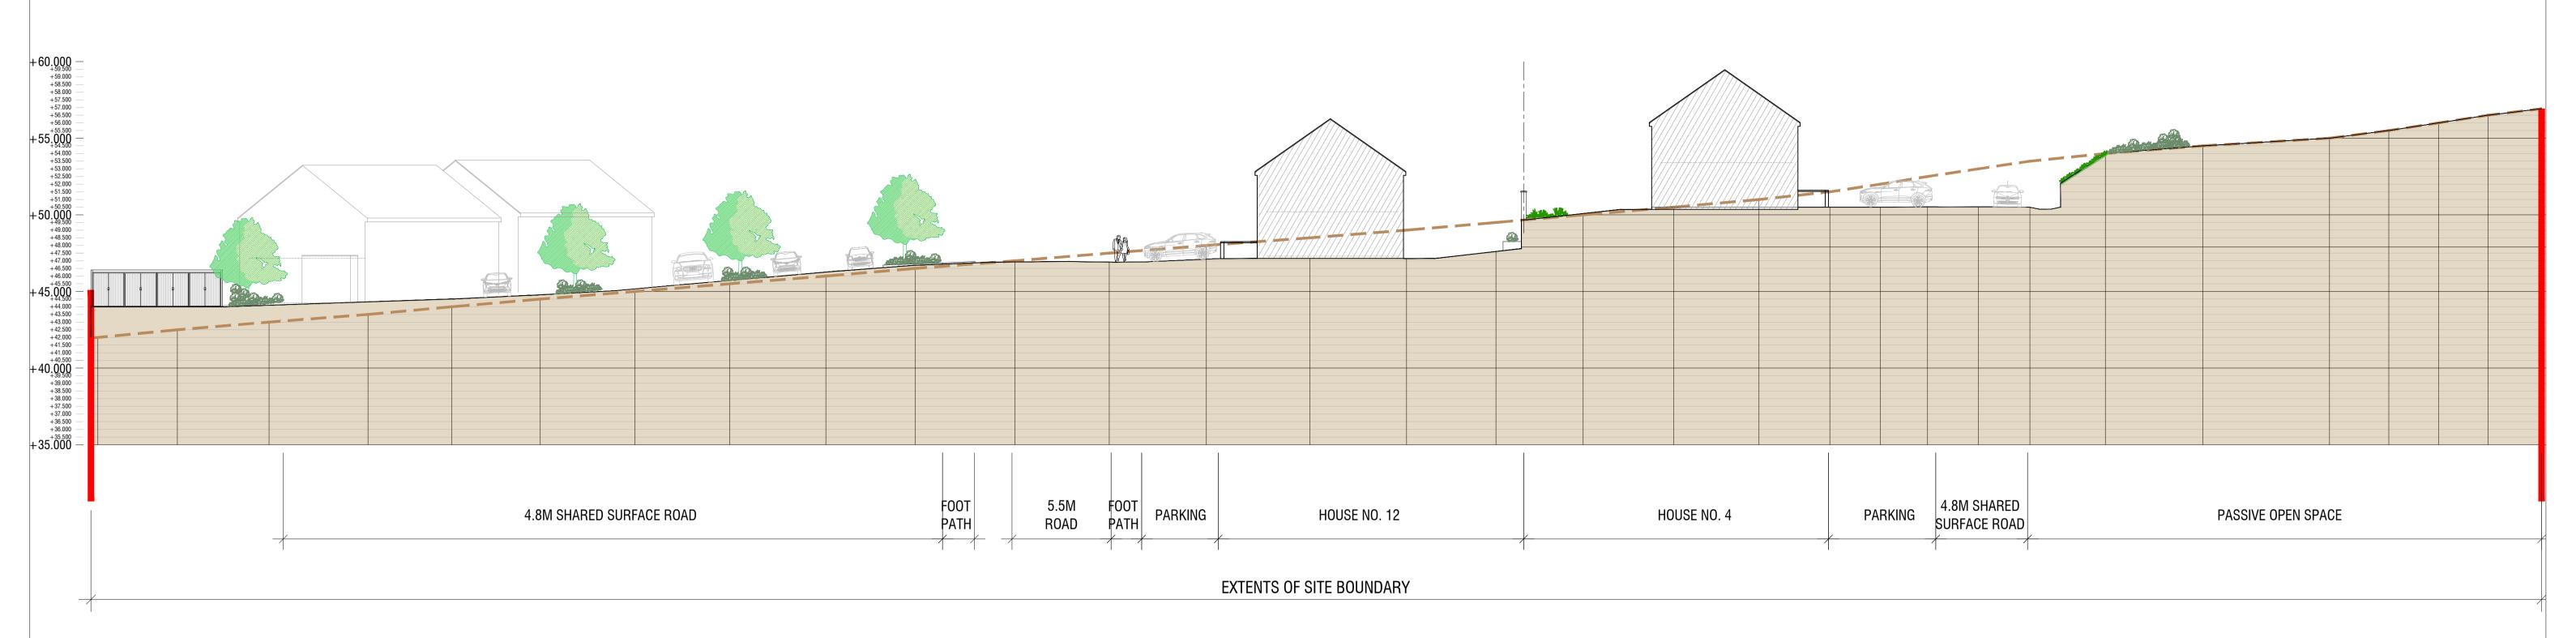






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PROJECT:	RESIDENTIA	L DEVELOPMENT, I	BROOM	MFIELD, M	IDLETON	JOB NO: 24026		
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PROJECT: RESIDENTIA	L DEVELOPMENT, E	BROOM	ИFIELD, MI	DLETON	JOB NO: 24026		
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SERIES: PLANNING	SCALE: 1:200	A1	DATE:	09/09/2024	PL03		

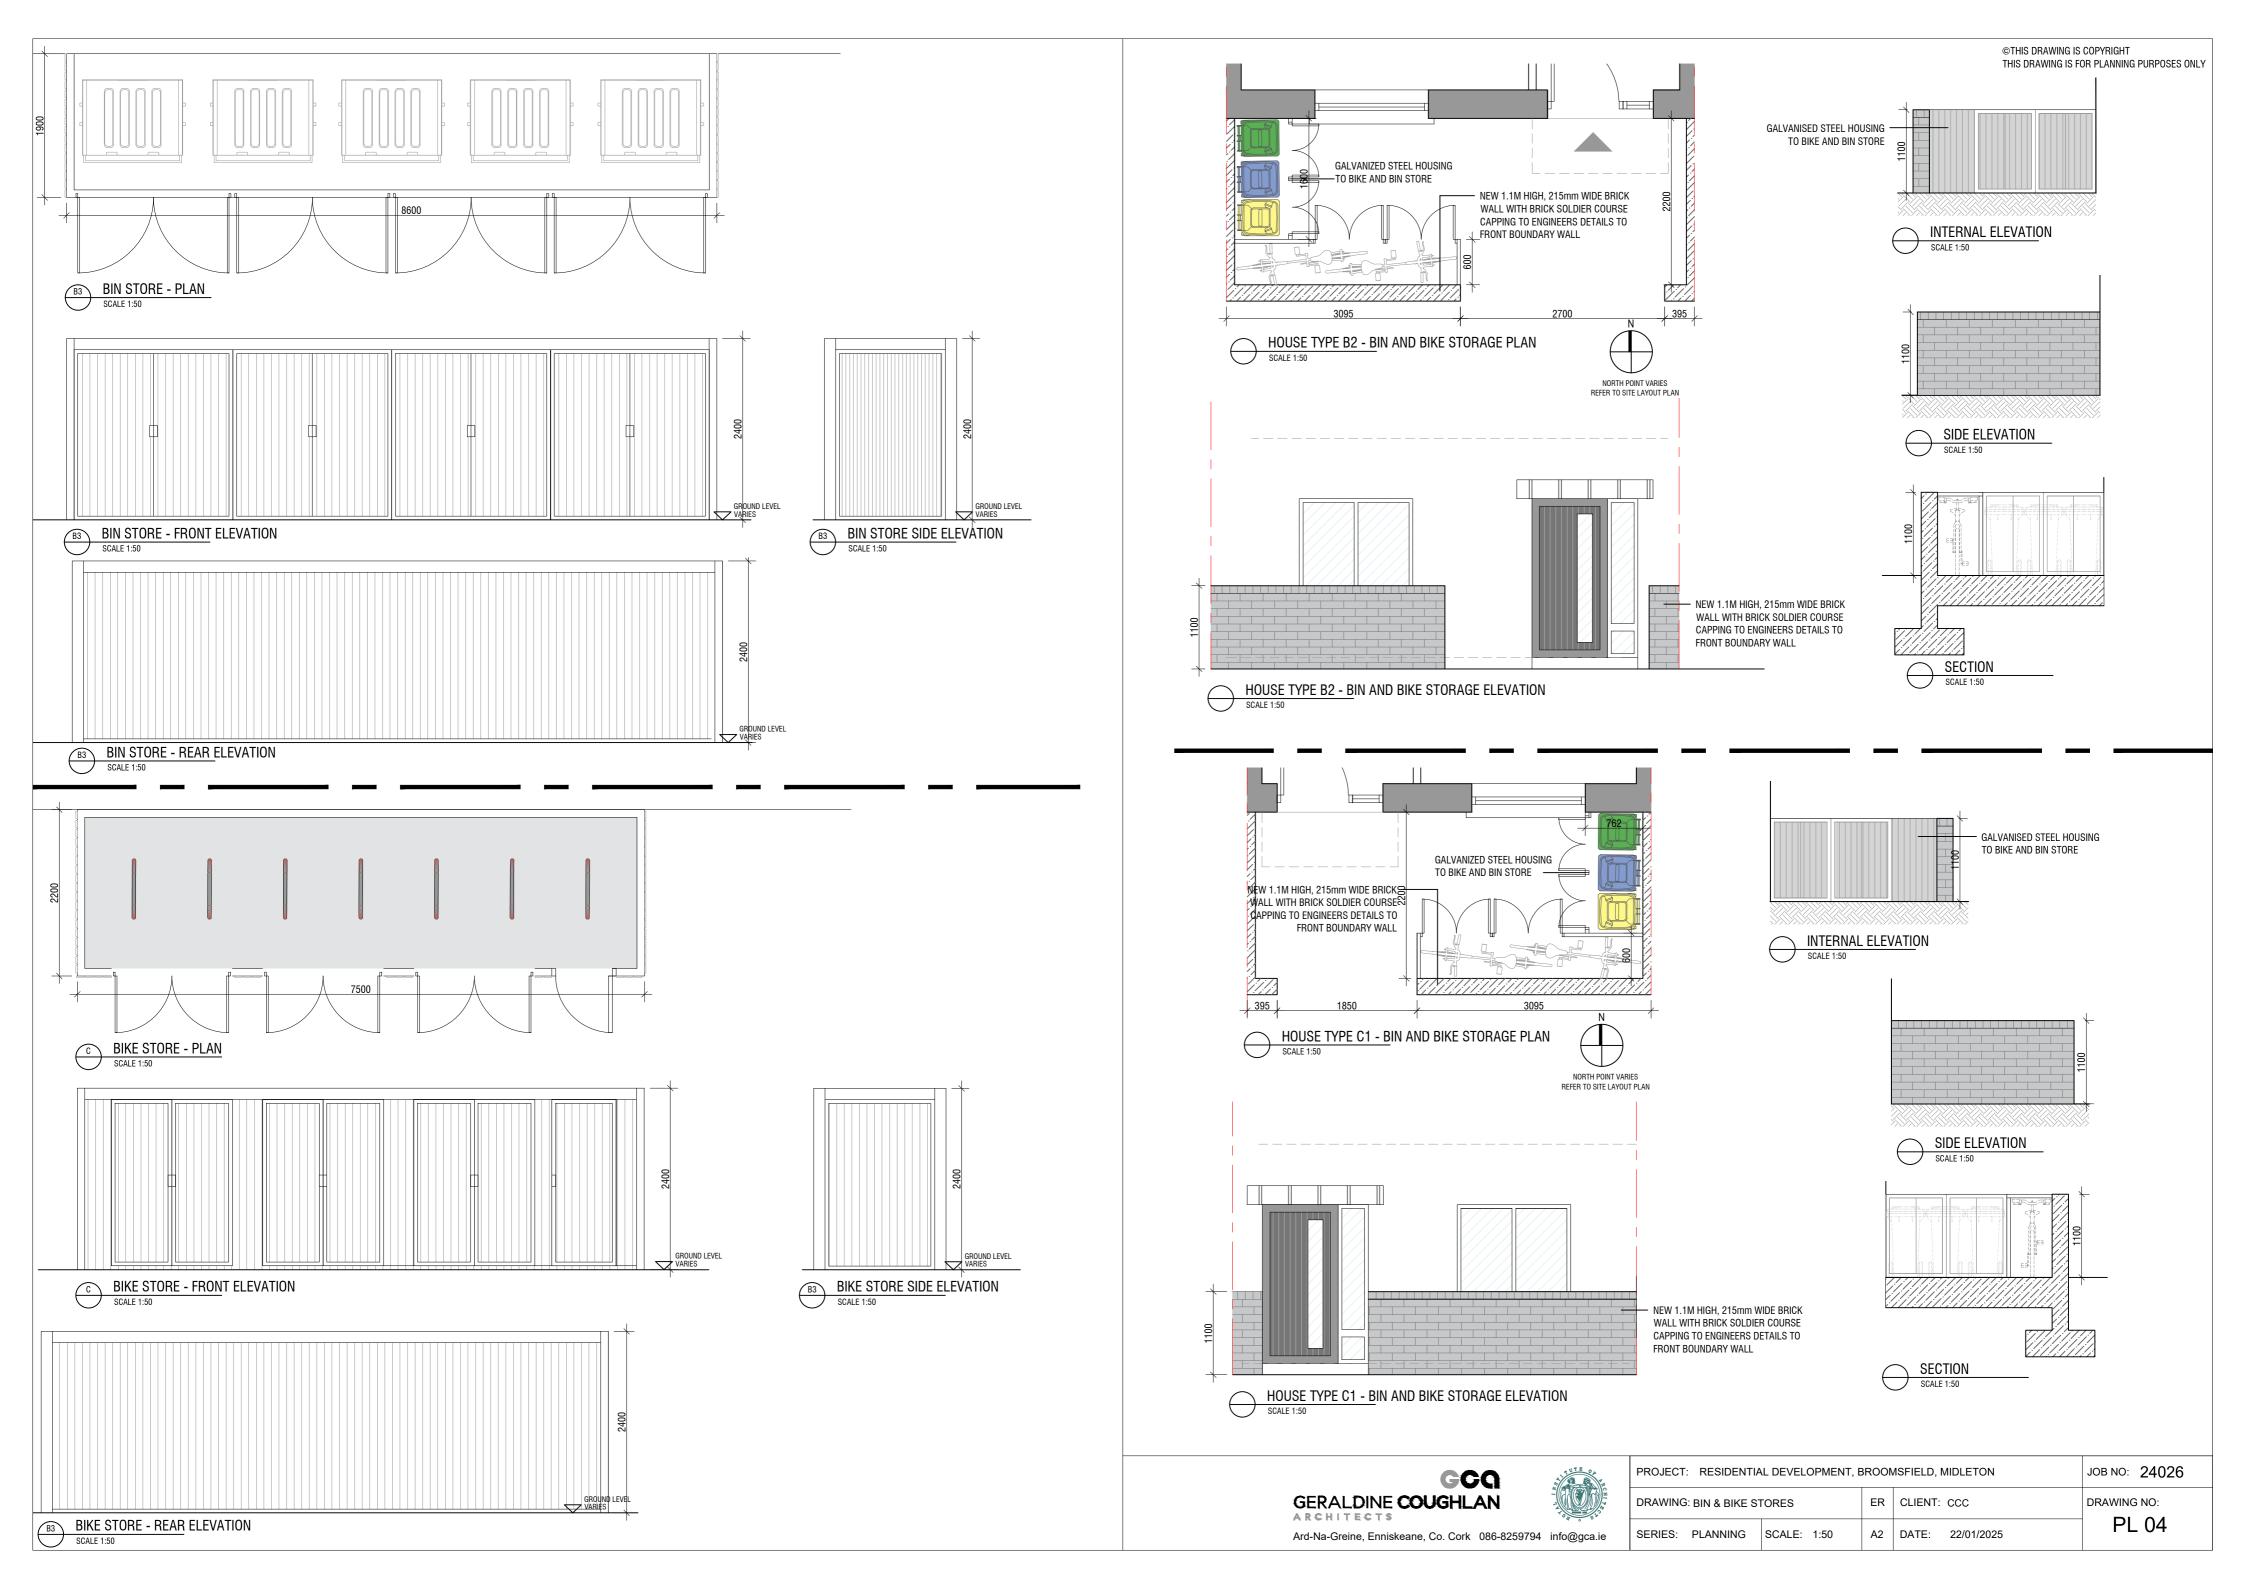

ARCHITECTURAL DESIGN STATEMENT



INTRODUCTION

The proposal is for a residential development on lands at Broomsfield West, Midleton, Co. Cork. The subject site is c. 1.2 kilmeteres North of Midleton town. .

These are a mix of terraced, and semi detached 2, 3 and 4 bedroom dwelling houses. There are 1 and 2 bedroom apartments and simplexes. The proposed development is located on a key site within Midleton's settlemnet boundary and offers an opportunity to provide housing in a location close to the town centre and the existing Midleton Railway Station.

The proposed development is a natural progression to the town expansion and ties into the existing developments of Broomfiled Ridge, Blossom Hill, The Steeples, Elsinore and Abbeylands.


The design of the scheme has been informed following detailed consultation with Cork County Council. Aswell as the consultation process, due regard was given to the relevant planning policy documents including Guidelines for Planning Authorities on Sustainable Residential Development in Urban Areas (Cities, Towns & Villages), the Urban Design Manual - A best practice Guide and the Design Manual for Manual for Urban Roads and Streets and the 2022 Cork County Development Plan.

The site is zoned MD-R-26 under the Cork County Council Development Plan 2022 - 2028, which is Medium A Density Residential Development.



CONTENTS

12 URBAN DESIGN CRITERIA

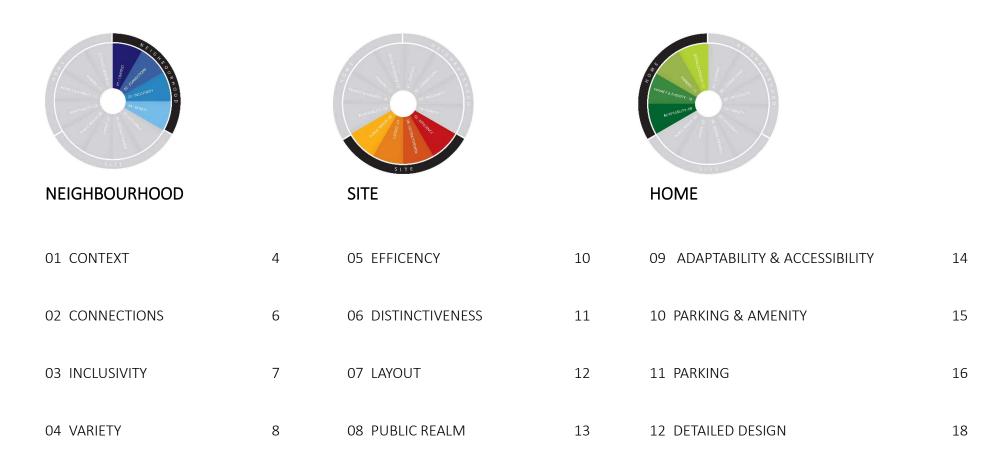

01 CONTEXT

The proposed development site of 1.45 ha is located within the townland of Broomsfield West., located c. 1.2 kilometers north of Midlteon. The site is accessed from the Broomfiled road (L7630). The subject site has a hilly topography sloping from North to South. The lands are greenfield. The proposal is for 1.45 hectares of development in the northern most part of a larger field. The remaining 3.32 hectares of land will be developed in the future.

There is existing housing estatse to the west and south (Elisnore and Abbeylands). The lands to the east have recently achieved planning permission for 272 residential units, creche and community use (Broomfield West LRD). There is a housing estate "The Steeples" nearing completion to the north. There is an existing Water Treatment Plant directly across the road to the east. The area is mainly well established housing estates.

The Midlteon Educate together National school is within 300 meters west of the site. A future bicycle and pedestrian link has been provided within the proposed scheme to link to the school.


The proposal is for 45 residential units on 1.45 hectares which is consistent with the MD-R-26 Zoning under the Cork County Council Development Plan 2022-2028.



01 CONTEXT



02 CONNECTIONS

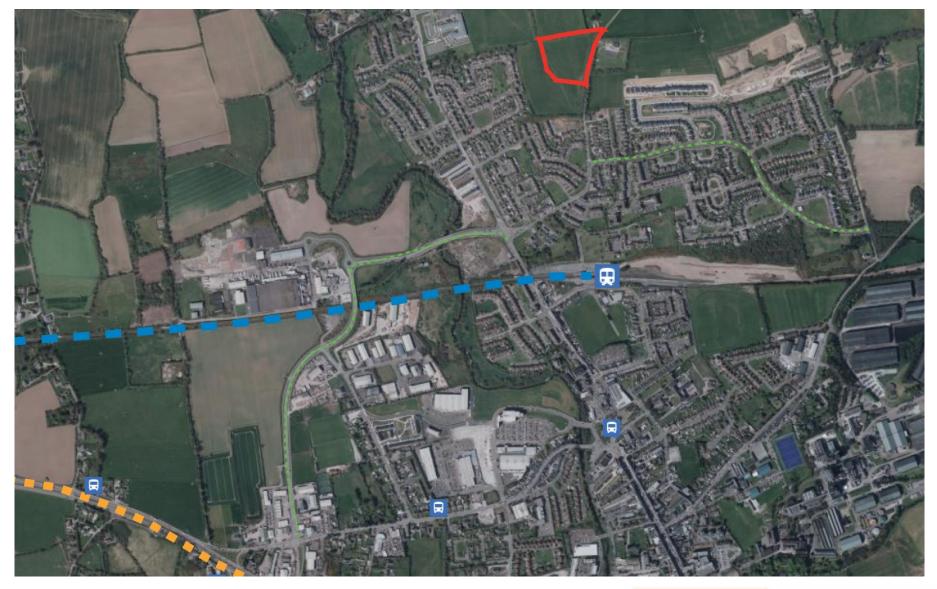

1 No. Vehicular entrance is proposed off the L7630 roadway bounding the eastern edge of the site. Upper Mill road is within 600 meters of the site. The N25 is within 2.5 kilometers of the site.

The train station is 650 meters away. It links Midleton to Cork and Mallow and also to Cobh. Midtleon is well served by bus connections, there are 4 no. bus services. There is a bus stop 1.5 kilometers away from the site.

There is full pedestrian path connectivity to Midleton town. A cycle path and pedestrian path runs through the proposed scheme terminating on the north west boundary, this will provide future access to The Educate Together Primary School located some 300 meters to the West.



03 INCLUSIVITY

A broad range of units are proposed, both in terms of unit size and configuration. There is a wide variety of house and apartment types. 1, 2, 3 and 4 bedroom units, including some specially designed age friendly units which are own door ground floor one bed apartments. These have wider entrance halls, larger bathrooms and general wheelchair manourvearbilty designed into the layouts. Additionally all houses are universally designed to provide access for a variety for age, size or ability.

All houses are provided with level access thresholds in accordance with TGD M. Most of the dwellings designed to be adaptable internally to facilitate life changes such as disability or the needs of older people.

Car parking is arranged for ease of use and accessibility with most parking provided within the curtilage of the dwelling unit. Level footpaths are provided wherever possible with footpaths being gently sloped where necessary.







MAIN VEHICULAR ROUTE
SHARED SURFACE
PEDESTRIAN ROUTE
CYCLE ROUTE



SIMPLEX BUILDINGS HOUSES



PUBLIC OPEN SPACE



PRIVATE OPEN SPACE

04 VARIETY

A particularly wide-ranging mix of housing types and sizes provide for diverse range of occupants. House sizes range from 2, 3 and 4 bedroom with dwelling types including terraced and semi-detached units. 1 and 2 bedroom apartments and simplexes are provided. All units will be designed with regard to Quality Housing for Sustainable Communities Best Practice Guidelines.

There are 3 no. 4 bedroom houses, 16 no. 3 bedroom houses and 8 no. 2 bedroom houses. There are 18 no. 1 and 2 bedroom simplex units. These are all own door units bar 2 no. simplex which share an entrance. A large proportion (9 no.) are accessible from ground floor.

An innovative approach has been proposed within the design to navigate the steep gradients throughout the design. For example some of the simplex units are designed within a split level building allowing the all units to be own door. The simplex units are all located to the south of the site to allow for generous semi- private open space to the front in a courtyard type arrangement which promotes social interaction. The design also allows for a almost flat open space provision outside the unit.



3 BED / 2 BED TERRACED DWELLINGS



SEMI DETACHED 4 BED / 3 BED DWELLINGS



SEMI DETACHED SAMPLE FLOOR PLANS

04 VARIETY




1 & 2 BED SIMPLEX UNITS



1 & 2 BED SIMPLEX UNITS



4 BED / 3 BED TERRACED DWELLINGS

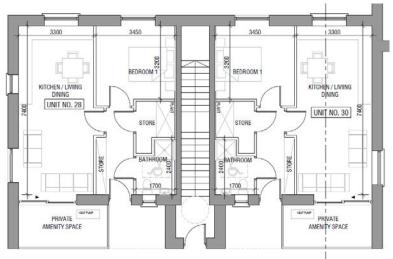

GROUND FLOOR SIMPLEX PLANS



4 BED TURN THE CORNER SAMPLE FLOOR PLANS

05 EFFICIENCY

The proposal is for 45 residential units on 1.45 Hectares with a developable area of 1.34 Hectares giving a density of 33.5 units to the hectare. 12.3% of the site (0.166 hectares) is set aside for usable public open space. The high quality landscape strategy provides for multiple interests including children's play spaces and social networking spaces.

All houses have been designed with regard to Quality Housing for Sustainable Communities Best Practice Guidelines. The individual floorspaces of each dwelling along with accompanying private open space exceeds the minimum standards. Minimising roads and vehicular circulation has also lent itself to an efficient layout.

The existing hilly topography of the site was carefully considered in the design. The split level design approach for the simplex units deals with site contours on the southern side of the site. These units are dual aspect and all own door accessed. This denser part of the scheme is centered around a courtard design on the southern most part of the site nearest Midleton town.



06 DISTINCTIVENESS

The proposed layout is designed to respond positively to the existing hilly topography of the site. The natural features existing on the site were incorporated into the layout.

The proposed dwelling design will progressively change throughout the site to provide variation and differentiation to the housing clusters. Whilst the form, architecture and landscape are consistent with the area, the development will form its own identity.

There are 2 distinct areas to the development, the southern development, "the courtyard", which is more urban in character with a tigher density. A range of simplex designs are arranged in a manner to create semi private open space to encourage social interaction to create an active neighbourhood. The units are designed to encourage a varied population with age and mobilty at the forefront. The defensible deisgn of the units allow for a self regulation environment with overlooking and passive supervsion of all public open space.

"The Green" is centrally located and has the largest public open space provision. All houses will be designed and sited to provide the maximum passive surveillance of the public realm, including streets, paths and open spaces.

Connectivity is at the core of the design, a 4m wide footpath and cycle path transversing the site, allowing for a future connection to The Educate Together School. This connectivity corridor is centrally located and facilitates pedestrian and cycle priority. There is permeability to the future adjacent development to the east and south east of the site.

The diverse housing mix and variety of accommodation will be a sustainable and important contribution to local housing market.





SHARED SURFACE PEDESTRIAN ROUTE CYCLE ROUTE



07 LAYOUT

The proposed layout allows the housing to take advantage of the existing site aspect and contours. The specifc design approcah was to manage the existing topography, minimise the cut and fill on the site and maximise the use of the public open spaces. The layout is defined by 2 large areas of open space. The area to the south of the site is a dense development of simplex units, these are carefully laid out in a courtyard style arrangement with some units being split level dual aspect providing a soltion to the constrainst of the site topography whilst achieving a high density target. The units have the added advantage of all being own door units, fully accesible.

The dwelling houses are arranged around a central green spaces as much as possible to provide passive supervision and easy connection to the public open spaces. The existing undevelopable area to the north is incorporated into the layout by orientering the adjoining houses to passively supervise the area.

Pedestrian permeability and connectivity is prioritised in the layout, with 2 metre wide footpaths, specific crossing points on desire lines and shared surfaces to promote pedestrian priority. Raised tables will reduce road speeds. The dedicated cycle land will eventually connect to The Educate Together School to the east of the site.

Roadways have been minimised and shared surfaces provided to prioritise the pedestrian experience. Regard has been given to the Design Manual for Urban Roads and Streets (DMURS) to create diverse shared space which is safe for future residents and visitors.



08 PUBLIC REALM

Just over 15.2% of the site is green space. The consists of buffer areas to the main road, green infastructure, bioretention rain garden, public open paces with paly areas and social interaction areas.

12.3% of the site is allocated as public open space, which is dispersed throughout the scheme. All public open spaces are overlooked by adjoining houses and simplex units providing strong defensible design and passive supervision. These public open spaces are connected by pedestrian paths and cycle paths, with play areas distributed. The designed amenity areas will offer access and encourage varying age groups and end users with varying levels of mobility. The amenity areas vary between parks, play spaces, semi-private social place making and biodiversity nodes.

Any boundaries defined by mature trees and hedgerows will be retained. The landscape plan will include native plant material to improve the overall biodiversity of the site.



Extract from DRLA Landscaping Layout Public Open Space



Extract from DRLA Landscaping Layout

Grass Mound

09 ADAPTABILITY & ACCESSIBILITY

Houses in the development can be easily adapted to future needs of occupants. The house types have been carefully designed to accommodate future extensions to the rear of the house with minimum impact on adjacent dwellings. Some of the houses have the potential to convert the attic space which would give further accommodation.

Multi-generational living has been incorporated into the house design brief.

All homes are designed to be energy efficient and to meet the latest Building Regulations.

All homes are designed in accordance with the "Quality Housing for Sustainable


Communities".

Some specific age friendly homes are designed into the scheme. These are own door access, one bedroom ground floor units. These units have larger bathrooms, hallways and have provison for greater mobility within the unit.



Ground Floor Plan of typical 4 bedroom house Universal Design and adaptability indicated In Red

First Floor Plan of typical 4 bedroom house

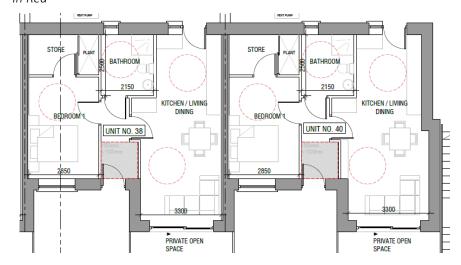

ACCESSIBLE AGE FRIENDLY GROUND FLOOR SIMPLEX PLANS

10 PRIVACY & AMENITY


Each house has access to generous private open space and each house is dual aspect and some are triple aspect. Almost all te simplex units are dual aspect and soome are triple aspect. Homes are carefully sited so that views directly into facing units are avoided. There is a minimum distance of 16 meters provided between houses back to back.

An average distance of 2.5m is provided between opposing gables of dwellings. Party walls are designed to prevent sound transmission between adjoining dwellings. A buffer zone is provided between ground floor units and public areas, creating a transition zone between public and private space.

All houses have private gardens, all simplexes have private terraces or balconies. All units will meet and most will exceed the Living Standards guidelines.



Extract from site plan indicating aspects

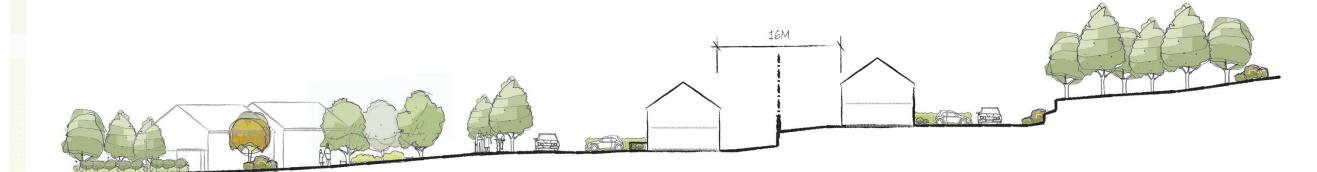


Sketch Site Section

11 PARKING

There are two spaces provided for each three and four bed houses and one parking space provided for each two bed house. Parking is located so that cars are overlooked by surrounding houses and passing motorists or pedestrians.


Every dwelling will have the capacity to have their own EV parking space or spaces.

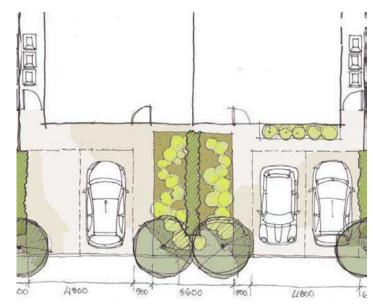

Sample of two spaces outside houses



Sample of paving sets outlined for front garden spaces

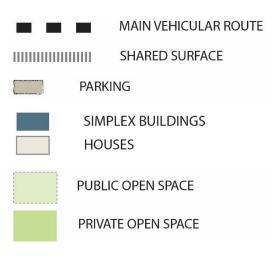



BICYCLE PARKING

The houses with external garden access will use their back gardens to store their bicycles.

For the Apartments, Simplexes and townhouses the bicycle parking facilities have been assigned as follows in compliance with **Standards for Cycle Parking and associated Cycling**Facilities for New Developments:

Resident Spaces: 1 no. private bike spaces per housing unit (27 no. spaces)

Apartments: 1 no. long stay parking space per bedroom. (26 no. spaces)

Visitor Spaces: 1 no. space per 5 units for houses and 1 no. space per 2 units for

apartments. (15 no. spaces)

Total number of bicycle spaces provided : 68 no. Spaces

All bicycle parking spaces are located in central locations dispersed within the scheme which are overlooked and secured by passive surveillance . All racks will be covered 'Sheffield' cycle stands.



Sample of Bin & Bike Store for rear gardens

MAIN VEHICULAR ROUTE

SHARED SURFACE

BIC


BICYCLE PARKING



PARKING



SIMPLEX BUILDINGS HOUSES

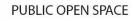

PRIVATE OPEN SPACE



12 DETAILED DESIGN


The scheme proposes a soft palette of materials with the wall materials proposed to be a light coloured palette of self coloured wet dash render and brick. The extruded side elevation detail for the corner houses will be brick. Coloured PVC windows are proposed.

The brick walls are used strategically for the publically visible boundary walls. Additionally the boundary treatments will help in place making and orientation.

The buildings will be constructed of traditional materials (i.e timber frame, blockwork, slate etc.) with all materials chosen for durability. Elevational treatment and features will differ throughout the site to create distinct character areas. The features such as mono pitch roofs, pressed metal canopies and brick elevation details give a unique character to the development. The wide variety of units will also ensure character setting. High quality soft and hard landscaping will compliment the designs.



Sample of Proposed Canopies

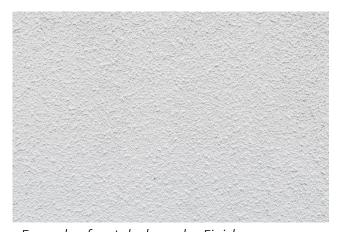

Example of wet dash render Finish



Example of Brick Finish



VIEW FROM MAIN ENTRANCE ROAD



SIMPLEX COURTYARD



PUBLIC OPEN SPACE, CHILDRENS PLAY AREA



PUBLIC OPEN SPACE, CHILDRENS PLAY AREA



3 BED TERRACED HOUSES



UPPER SITE

HOUSING QUALITY ASSESSMENT

HOUS	ING QU	JALITY ASSESSMENT																				
SITE NO.	HOUSE TYPE	UNIT DESCRIPTION	UNIT AREA REQUIRED (m2)	UNIT AREA ACHIEVED (m²)	10% OVER AREA REQUIREMENT (Y/N)	DUAL ASPECT	ASPECT	BEDROOMS	BEDSPACES	CELLING HEIGHT (m²) (Kitchen/Living/Dinin	Aggregate Bedroom Areas Required (m2)	Aggregate Bedroom Areas Achieved (m²)	Main Living Room Width Required (m2)	Main Living Room Width Achieved (m²)	Kitche/Living/Dining Area Required (m2)	Kitche/Living/Dining Area Achieved (\mathfrak{m}^2)	Main Living Room Area Required (m2)	Main Living Room Area Achieved (m2)	Aggregate Storage Area Required (m2)	Aggregate Storage Area Achieved (\mathfrak{m}^2)	Private Amenity Space Required (m2)	Private Amenity Space Achieved (m²)
1	B1	SEMI	92	100.1	N	YES	S-W, N-E	3	5	2.45	32	33.5	3.8	3.8	34	37.6	13	14.4	5	5.5	40	144
2	B1.1	SEMI	92	100.1	N	YES	S-W, N-E	3	5	2.45	32	33.5	3.8	3.8	34	37.6	13	14.4	5	5.5	40	62.1
3	C2	SEMI	80	85.1	N	YES	S-W, N-E	2	4	2.45	25	25.8	3.6	4.95	30	32.2	13	16.5	4	5.6	30	55.7
4	C1	SEMI	80	85.1	N	YES	S-W, N-E	2	4	2.45	25	25.8	3.6	4.95	30	32.2	13	16.5	4	5.6	30	44.3
5	B1.1	SEMI	92	100.1	N	YES	S-W, N-E	3	5	2.45	32	33.5	3.8	3.8	34	52.4	13	14.4	5	5.5	40	62.8
6	A2	SEMI	110	118.5	N	YES	S-E,N-W	4	7	2.45	43	43.4	3.8	3.9	40	41.6	15	19.7	6	6.4	50	63.7
7	B4	SEMI	92	100.1	N	YES	S-E,N-W	3	5	2.45	32	33.5	3.8	3.8	34	37.6	13	14.8	5	5.5	40	72.2
8	C2	SEMI	80	85.1	N	YES	S-E,N-W	2	4	2.45	25	25.8	3.6	4.95	30	32.2	13	16.5	4	5.6	30	68.6
9	C1.1	SEMI	80	85.1	N	YES	S-E,N-W	2	4	2.45	25	25.8	3.6	4.95	30	32.2	13	16.5	4	5.6	30	54.1
10	B5	SEMI	92	99.2	N	YES	S-E,N-W	3	5	2.45	32	32	3.8	3.8	34	38	13	16	5	5.3	40	120
11	B1	END OF TERRACE	92	100.1	N	YES	S-W, N-E	3	5	2.45	32	33.5	3.8	3.8	34	37.6	13	14.4	5	5.5	40	62.8
12		MID TERRACED	92	100.1	N	YES	S-W, N-E	3	5	2.45	32	33.5	3.8	3.8	34	37.6	13	14.4	5	5.5	40	48.9
13		MID TERRACED	92	100.1	N	YES	S-W, N-E	3	5	2.45	32	33.5	3.8	3.8	34	37.6	13	14.4	5	5.5	40	48.9
14		END OF TERRACE	92	100.1	N	YES	S-W, N-E	3	5	2.45	32	33.5	3.8	3.8	34	37.6	13	14.4	5	5.5	40	62.8
15	B1	END OF TERRACE	92	100.1	N	YES	S-W, N-E	3	5	2.45	32	33.5	3.8	3.8	34	37.6	13	14.4	5	5.5	40	62.8
16	B2	MID TERRACED	92	100.1	N	YES	S-W, N-E	3	5	2.45	32	33.5	3.8	3.8	34	37.6	13	14.4	5	5.5	40	61.4
17	A1	END OF TERRACE	110	118.5	N	YES	S-W, N-E	4	7	2.45	43	43.4	3.8	3.9	40	41.9	15	18.6	6	6	50	56.7
18	A3	SEMI	110	115.8	N	YES	S-E,N-W	4	7	2.45	43	43.4	3.8	3.9	40	43.5	15	15.9	6	6	50	53.8
19	B1.1	SEMI	92	100.1	N	YES	S-E,N-W	3	5	2.45	32	33.5	3.8	3.8	34	37.6	13	14.4	5	5.5	40	51.6
20	B1	SEMI	92	100.1	N	YES	S-E,N-W	3	5	2.45	32	33.5	3.8	3.8	34	37.6	13	14.4	5	5.5	40	51.6
21	B1.1	SEMI	92	100.1	N	YES	S-E,N-W	3	5	2.45	32	33.5	3.8	3.8	34	37.6	13	14.4	5	5.5	40	51.6
22	B6	END OF TERRACE	92	100.1	N	YES	S-W, N-E	3	5	2.45	32	33.5	3.8	3.8	34	37.6	13	14.4	5	5.5	40	76.3
23	C1.1	MID TERRACED	80	85.1	N	YES	S-W, N-E	2	4	2.45	25	25.8	3.6	4.95	30	32.2	13	16.5	4	5.6	30	50.9
24	C2.1	END OF TERRACE	80	85.1	N	YES	S-W, N-E	2	4	2.45	25	25.8	3.6	4.95	30	32.2	13	16.5	4	5.6	30	61.9
25	C2	END OF TERRACE	80	85.1	N	YES	S-W, N-E	2	4	2.45	25	25.8	3.6	4.95	30	32.2	13	16.5	4	5.6	30	61.9
26	C1	MID TERRACED	80	85.1	N	YES	S-W, N-E	2	4	2.45	25	25.8	3.6	4.95	30	32.2	13	16.5	4	5.6	30	50.9
27	В3	END OF TERRACE	92	99.2	N	YES	S-W, N-E	3	5	2.45	32	32	3.8	3.8	34	38	13	16	5	5.3	40	146.4
28	D1	APARTMENT	45	50.6	Y	YES	S-W, N-W	1	2	2.45	11.4	11.5	3.3	3.3	23	24.9	N/A	N/A	3	3	5	7.2
29	D1	APARTMENT	45	50.6	Υ	YES	N-E, N-W	1	2	2.45	11.4	11.4	3.3	3.95	23	23.1	N/A	N/A	3	4.17	5	12.4
30	D1	APARTMENT	45	50.6	Υ	YES	S-W, S-E	1	2	2.45	11.4	11.5	3.3	3.3	23	24.9	N/A	N/A	3	3	5	7.2
31		APARTMENT	45	50.6	Y	YES	S-E, N-E	1	2	2.45	11.4	11.4	3.3	3.95	23	23.1	N/A	N/A	3	4.17	5	12.4
32	D1	APARTMENT	73	76.4	N	YES	S-W, N-W	2	4	2.45	24.4	24.7	3.6	3.885	30	30.7	N/A	N/A	6	6	7	10.3
33		APARTMENT APARTMENT	73	76.4	N Y	YES YES	S-W, N-W	2	4	2.45 2.45	24.4	24.5	3.6	3.8	30	30	N/A	N/A	6 5	6	7	8.29
34			63	63			S-W, N-W		3		20.1	20.2	3.3	3.65	28	29.2	N/A	N/A		5.3	6	8.6 9.5
35	D2	APARTMENT	63	63	Y	YES	N-E, N-W	2	3	2.45	20.1	20.3	3.6	3.65	28	29.2	N/A	N/A	5	5.3	6	
36	D2	APARTMENT	45	52	Y	YES	S-W, N-E	1	2	2.45	11.4	11.8	3.3	3.3	23	24	N/A	N/A	3	3.2	5 5	6.2 6.4
37	D2	APARTMENT	45	52	Y	YES	S-W, N-E	1	2	2.45	11.4	11.8	3.3	3.615	23	25.2	N/A	N/A	3	3.4		
38	D2 D2	APARTMENT APARTMENT	45 45	52 52	Y	YES YES	S-W, N-E	1	2	2.45 2.45	11.4 11.4	11.8 11.8	3.3 3.3	3.3 3.615	23	24 25.2	N/A N/A	N/A N/A	3	3.2	5 5	6.2 6.4
							S-W, N-E				11.4			3.615						3.4		6.4
40		APARTMENT	45 45	52.6	Y	YES	S-W, N-E	1	2	2.45 2.45	11.4	11.8 13.8	3.3		23	24.6	N/A N/A	N/A	3	3.2	5 5	6.2
41	D2 D3	APARTMENT APARTMENT	73	52.6 76.7	Y	YES YES	S-W, N-E S-E,N-W	2	4	2.45		24.5	3.3 3.6	4.765	30	24.6 30.1		N/A N/A			7	8.7
	_										24.4			3.8			N/A		6	6		
43	D3 D3	APARTMENT APARTMENT	73 73	76.7 76.3	Y	YES YES	S-E,N-W S-E,N-W	2	4	2.45 2.45	24.4 24.4	25.3 25.7	3.6 3.6	3.8	30 30	30.2 30	N/A N/A	N/A N/A	6	6.2	7	10.1 11.4
44		APARTMENT	45	76.3	Y	YES	S-E,N-W	2	4	2.45	24.4	24.5	3.6	3.8	30	30	N/A N/A	N/A N/A	6	6.6	7	7
45	υs	APAKTIVIENT	45	/0.3	T	153	3-E,IN-VV	2	4	2.45	24.4	24.5	3.0	3.0	30	30	N/A	IV/A	D	0.0	/	/



Proposed Residential Development at Broomfield, Midleton, Co. Cork Schedule of Accommodation

Prepared on behalf of Cork County Council

CONTENTS

1.0 Sch	edule of Accommodation Summary	2
	Dwelling Houses	
1.2	Apartments	2
2.0 Uni	t Breakdown	3
2.1	Dwelling Houses	-
2.1	Dwelling nouses	. 3
2.2	Anartments	2

1.0 Schedule of Accommodation Summary

1.1 Dwelling Houses		
Unit Type	No. of Units	Gross floor space in m ²
2-bed	8	680.8
3-bed	16	1599.8
4-bed	3	352.8
Total	27	2633.4m2

1.2 Apartments		
Unit Type	No. of Units	Gross floor space in m ²
1-bed	10	515.6
2-bed	8	620.7
Total	18	1136.3m2

Total number of residential units in proposed development:	45
Cumulative gross floor space of residential accommodation, in m ² :	3769.7

2.0 Unit Breakdown

2.1 Dwelling Houses

Unit Type	Form	No. of Beds	Size (sqm)	Total No. of Units Proposed
A1, A2	Semi-Detached	4	118.7	2
A3	Semi-Detached	4	115.8	1
B1, B1.1, B4	Semi-Detached	3	100.1	6
B2	Terraced	3	100.1	3
B1, B1.1	End of Terrace	3	100.1	4
B3	End of Terrace	3	99.2	1
B5	End of Terrace	3	99.2	1
В6	End of Terrace	3	100.1	1
C1, C1.1	Terraced	2	85.1	4
C2, C2.1	End of Terrace	2	85.1	4
Total				27

2.2 Apartments


Unit Type (Block Name)	Form	Apartment No.	No. of Beds	Sizes Per Unit (m²)	Total No. of Units	Sub Total Unit Areas (m²)
		28-31	1	50.6	4	202.4
D1	Simplex	32-33	2	76.4	2	152.8
		34-35	2	63	2	126
D2	Simplex	36-39	1	52	4	208
		40-41	1	52.6	2	105.2
D3	Simplex	42-43	2	76.7	2	153.4
		44-45	2	76.3	2	152.6
	Stairwells					35.9
Total					18	1136.3m2


Unit Size in Beds (Including Houses and simplex)	Total Proposed	% Mix
4	3	6.7%
3	16	35.6%
2	16	35.6%
1	10	22.2%









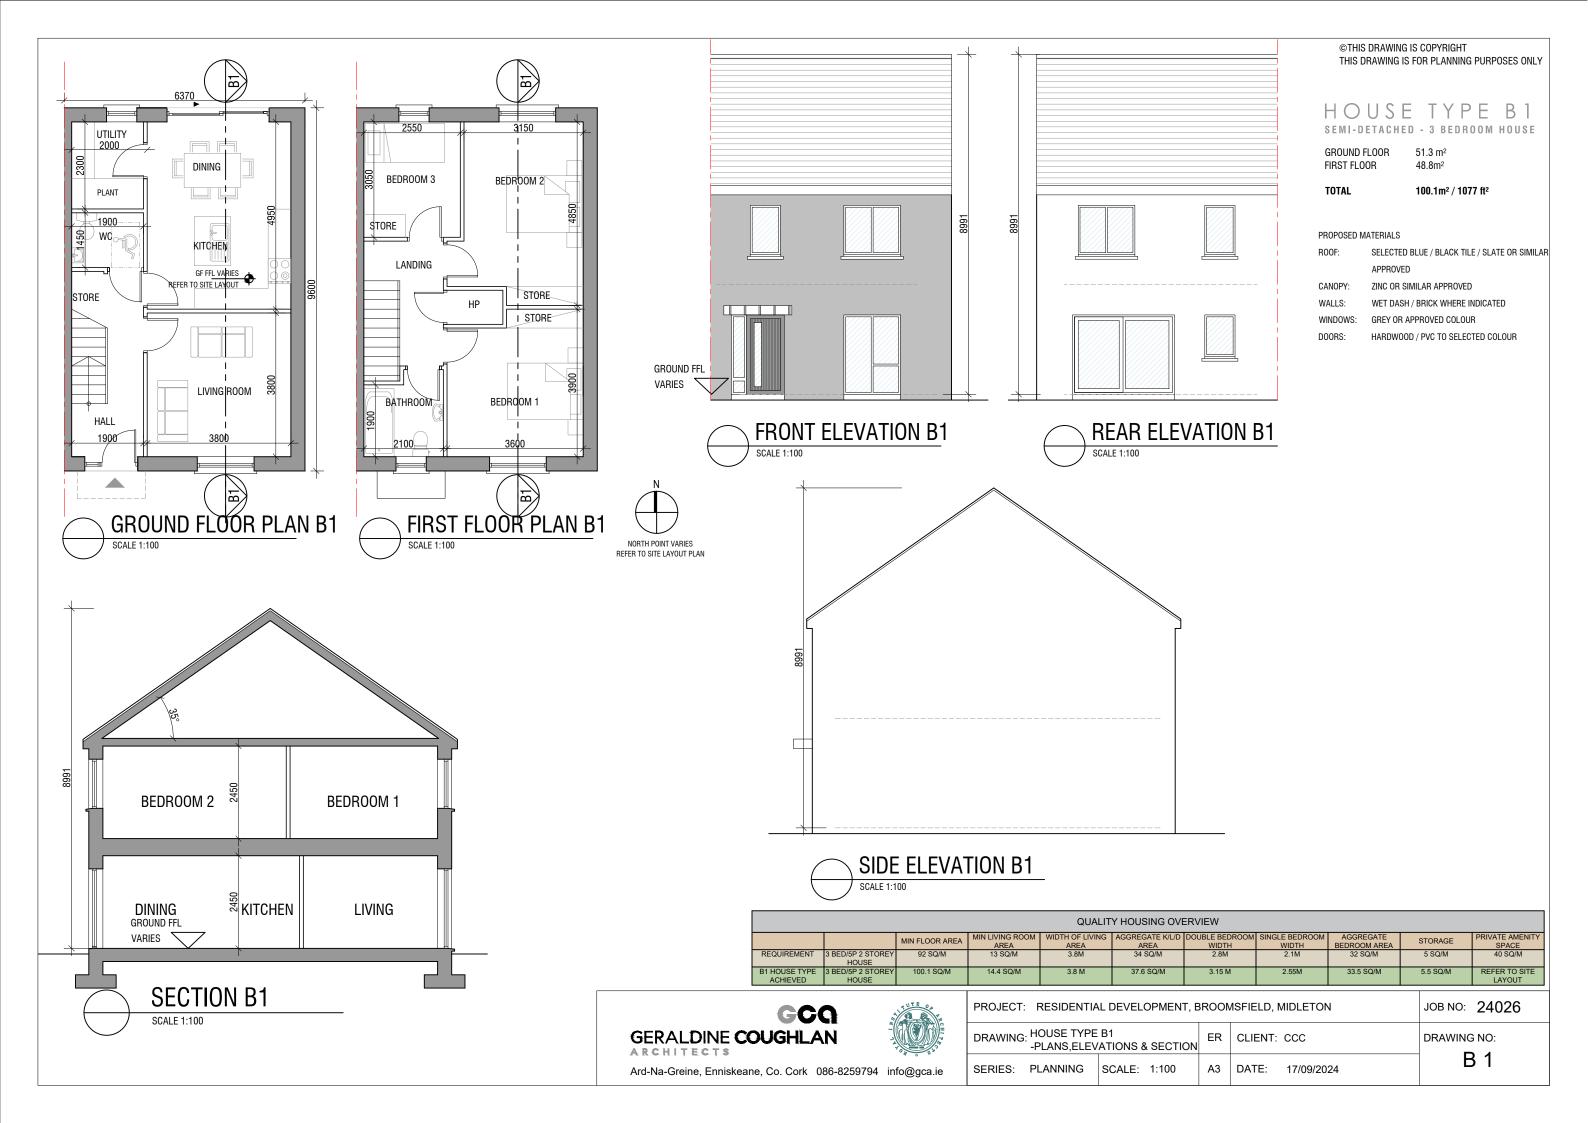

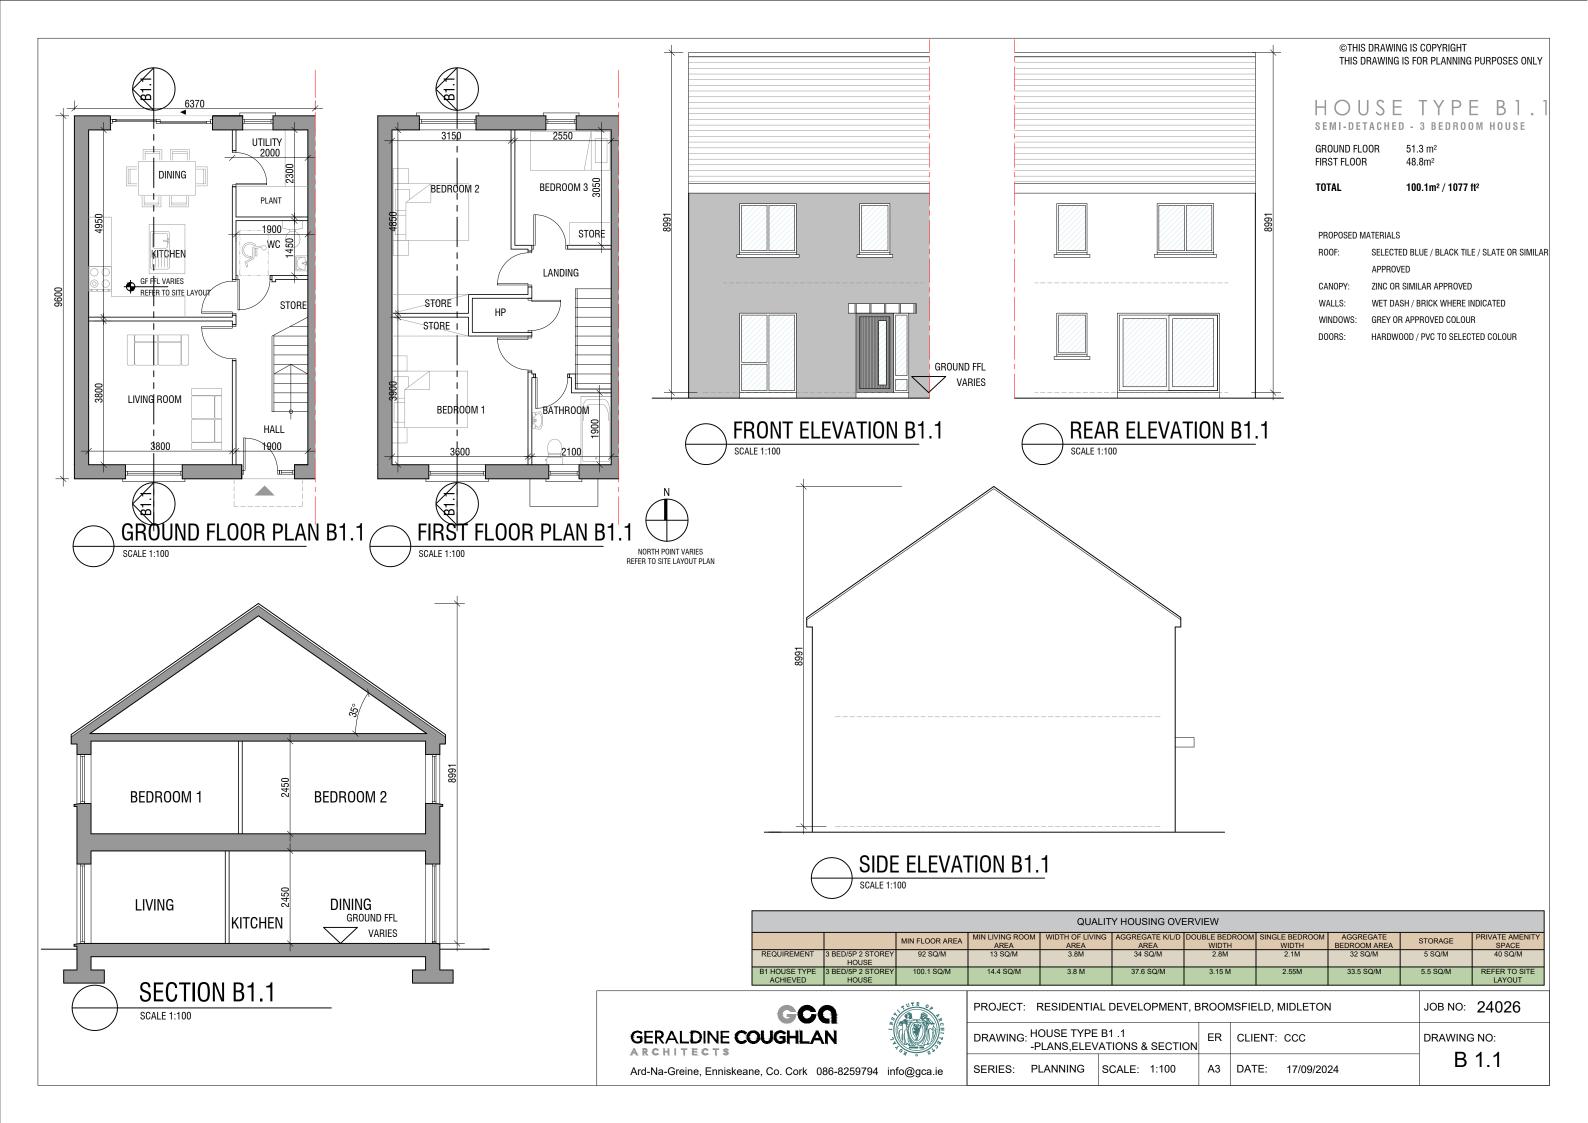

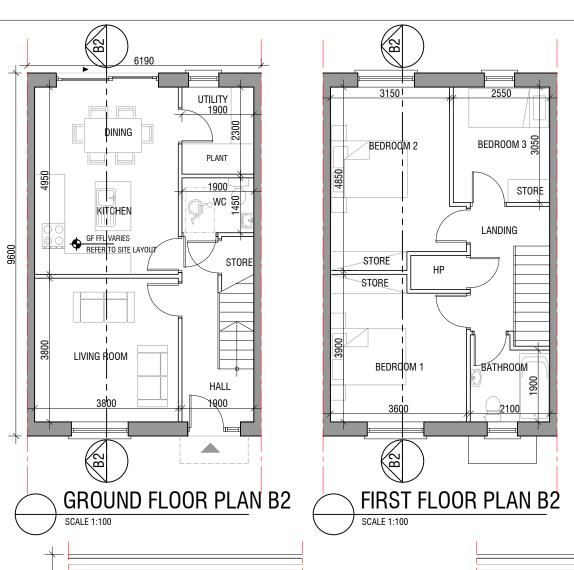

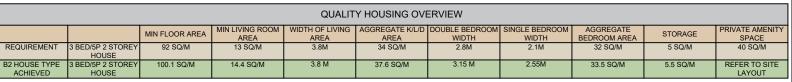

HOUSE TYPE B2

TERRACED - 3 BEDROOM HOUSE

GROUND FLOOR 51.3 m² FIRST FLOOR 48.8m²

TOTAL 100.1m² / 1077 ft²

PROPOSED MATERIALS

ROOF: SELECTED BLUE / BLACK TILE / SLATE OR SIMILAR

APPROVED

CANOPY: ZINC OR SIMILAR APPROVED

WALLS: WET DASH / BRICK WHERE INDICATED

WINDOWS: GREY OR APPROVED COLOUR

DOORS: HARDWOOD / PVC TO SELECTED COLOUR

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REAR ELEVATION B2

SCALE 1:100



BEDROOM 1

LIVING

SCALE 1:100

SECTION B2

PROJECT: RESIDENTIAL DEVELOPMENT, BROOMSFIELD, MIDLETON JOB NO: 24026									
DRAWING: HOUSE TYPE -PLANS,ELEV	B2 ATIONS & SECTION	ER	CLIENT: CCC	DRAWING NO:					
SERIES: PLANNING	SCALE: 1:100	А3	DATE: 17/09/2024	B 2					


BEDROOM 2


DINING GROUND FFL VARIES

KITCHEN \$\frac{\cein}{2}\$



Ard-Na-Greine, Enniskeane, Co. Cork 086-8259794 info@gca.ie

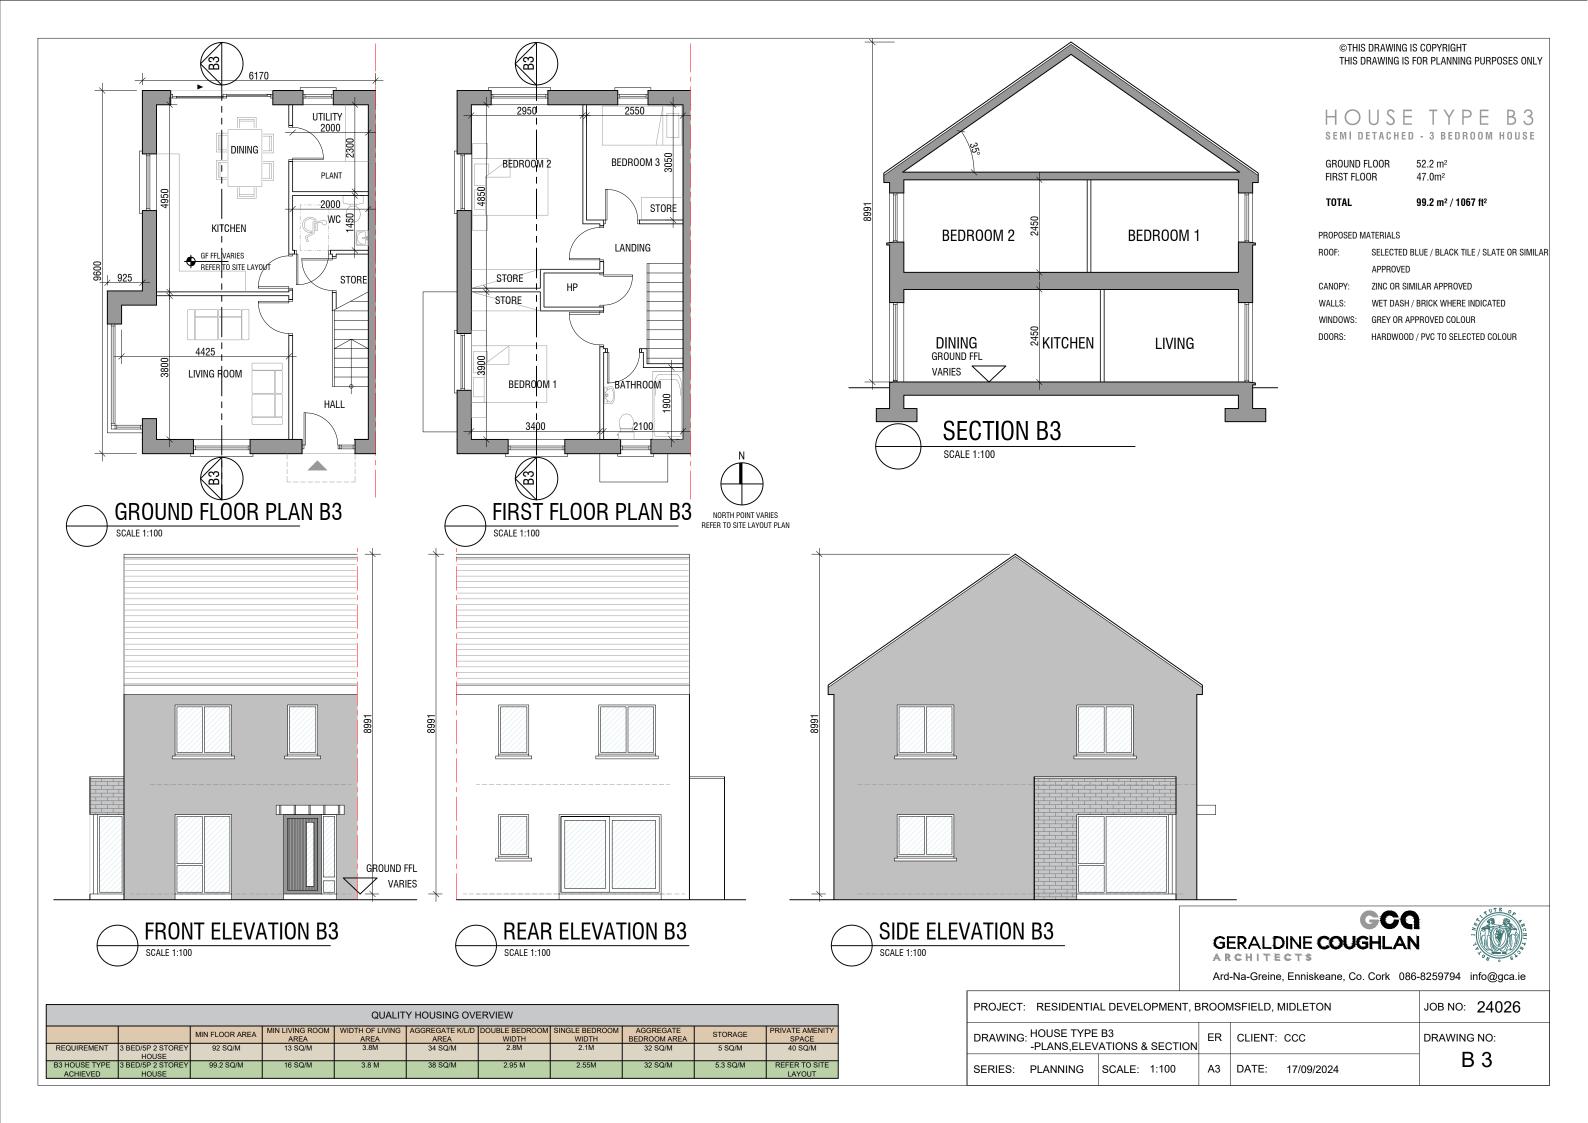

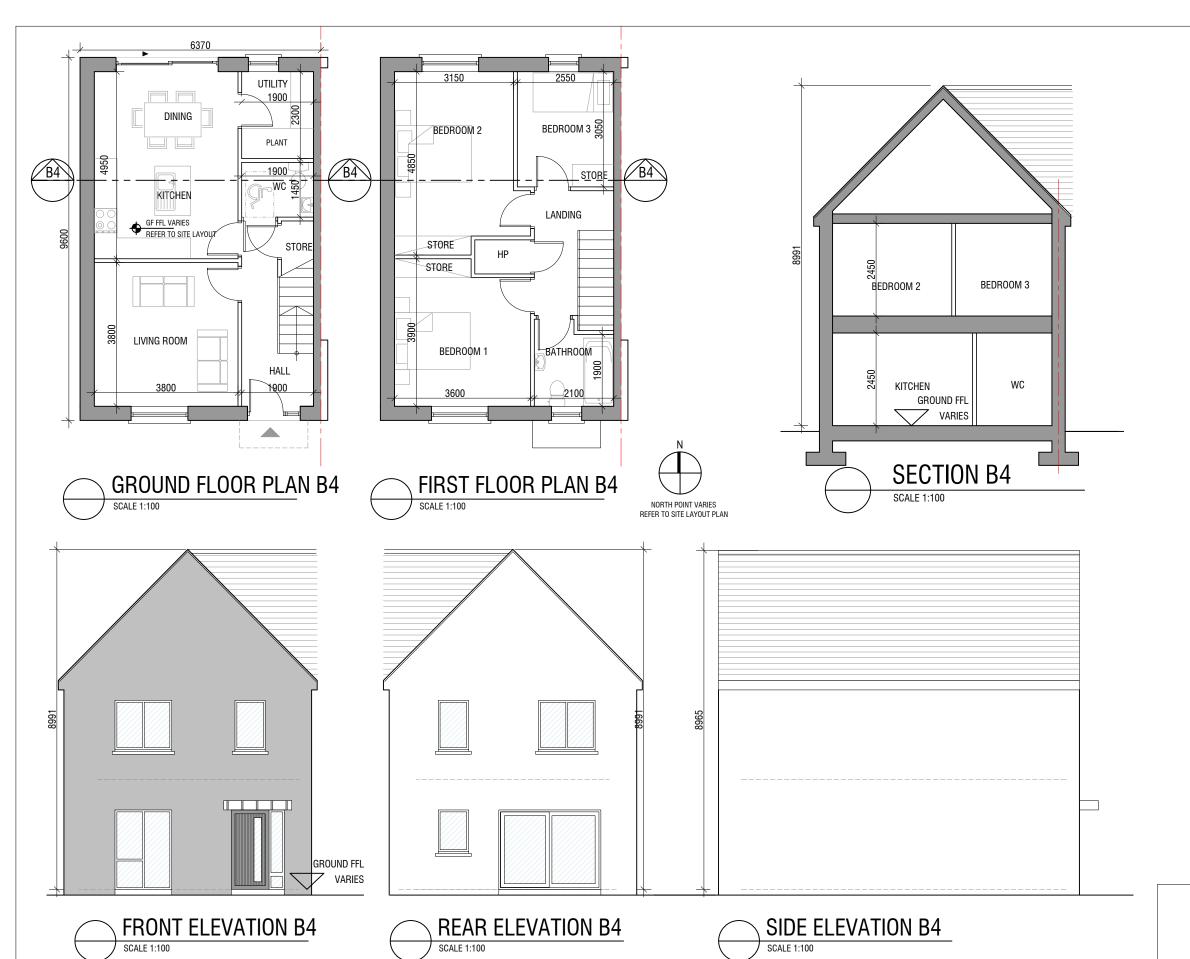

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HOUSE TYPE B4 SEMI-DETACHED - 3 BEDROOM HOUSE

GROUND FLOOR 51.3 m² FIRST FLOOR 48.8m²

TOTAL 100.1m² / 1077 ft²

PROPOSED MATERIALS

ROOF: SELECTED BLUE / BLACK TILE / SLATE OR SIMILA

CANOPY: ZINC OR SIMILAR APPROVED

WALLS: WET DASH / BRICK WHERE INDICATED

WINDOWS: GREY OR APPROVED COLOUR

HARDWOOD / PVC TO SELECTED COLOUR

GCQ **GERALDINE COUGHLAN**



Ard-Na-Greine, Enniskeane, Co. Cork 086-8259794 info@gca.ie

	QUALITY HOUSING OVERVIEW													
		MIN FLOOR AREA	MIN LIVING ROOM AREA	WIDTH OF LIVING AREA	AGGREGATE K/L/D AREA	DOUBLE BEDROOM WIDTH	SINGLE BEDROOM WIDTH	AGGREGATE BEDROOM AREA	STORAGE	PRIVATE AMENITY SPACE				
REQUIREMENT 3	3 BED/5P 2 STOREY HOUSE	92 SQ/M	13 SQ/M	3.8M	34 SQ/M	2.8M	2.1M	32 SQ/M	5 SQ/M	40 SQ/M				
B4 HOUSE TYPE 3 ACHIEVED	3 BED/5P 2 STOREY HOUSE	100.1 SQ/M	14.8 SQ/M	3.8 M	37.6 SQ/M	3.15 M	2.55M	33.5 SQ/M	5.5 SQ/M	REFER TO SITE LAYOUT				

PROJECT: RESIDENT	AL DEVELOPMENT, E	BROOM	MSFIELD, MIDLETON	JOB NO: 24026
DRAWING: HOUSE TYP -PLANS,ELE	E B4 VATIONS & SECTION	ER	CLIENT: CCC	DRAWING NO:
SERIES: PLANNING	SCALE: 1:100	A3	DATE: 17/09/2024	B 4



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THIS DRAWING IS FOR PLANNING PURPOSES ONLY

HOUSE TYPE B5 SEMI-DETACHED - 3 BEDROOM HOUSE

GROUND FLOOR 52.2 m² FIRST FLOOR 47.0m²

TOTAL 99.2 m² / 1067 ft²

PROPOSED MATERIALS

ROOF: SELECTED BLUE / BLACK TILE / SLATE OR SIMILA

APPROVED

CANOPY: ZINC OR SIMILAR APPROVED

WALLS: WET DASH / BRICK WHERE INDICATED

WINDOWS: GREY OR APPROVED COLOUR

ORS: HARDWOOD / PVC TO SELECTED COLOUR


GERALDINE COUGHLAN



Ard-Na-Greine, Enniskeane, Co. Cork 086-8259794 info@gca.ie

	QUALITY HOUSING OVERVIEW												
		MIN FLOOR AREA	MIN LIVING ROOM AREA	WIDTH OF LIVING AREA	AGGREGATE K/L/D AREA	DOUBLE BEDROOM WIDTH	SINGLE BEDROOM WIDTH	AGGREGATE BEDROOM AREA	STORAGE	PRIVATE AMENITY SPACE			
REQUIREMENT	3 BED/5P 2 STOREY HOUSE	92 SQ/M	13 SQ/M	3.8M	34 SQ/M	2.8M	2.1M	32 SQ/M	5 SQ/M	40 SQ/M			
B5 HOUSE TYPE ACHIEVED	3 BED/5P 2 STOREY HOUSE	99.2 SQ/M	16 SQ/M	3.8 M	38.0 SQ/M	2.95 M	2.55M	32 SQ/M	5.3 SQ/M	REFER TO SITE LAYOUT			

PROJECT:	JOB NO:	24026						
DRAWING:	HOUSE TYPE -PLANS,ELEV	B5 ATIONS 8	SECTION	ER	CLIENT:	CCC	DRAWING	
SERIES:	PLANNING	SCALE:	1:100	А3	DATE:	17/09/2024	В	5

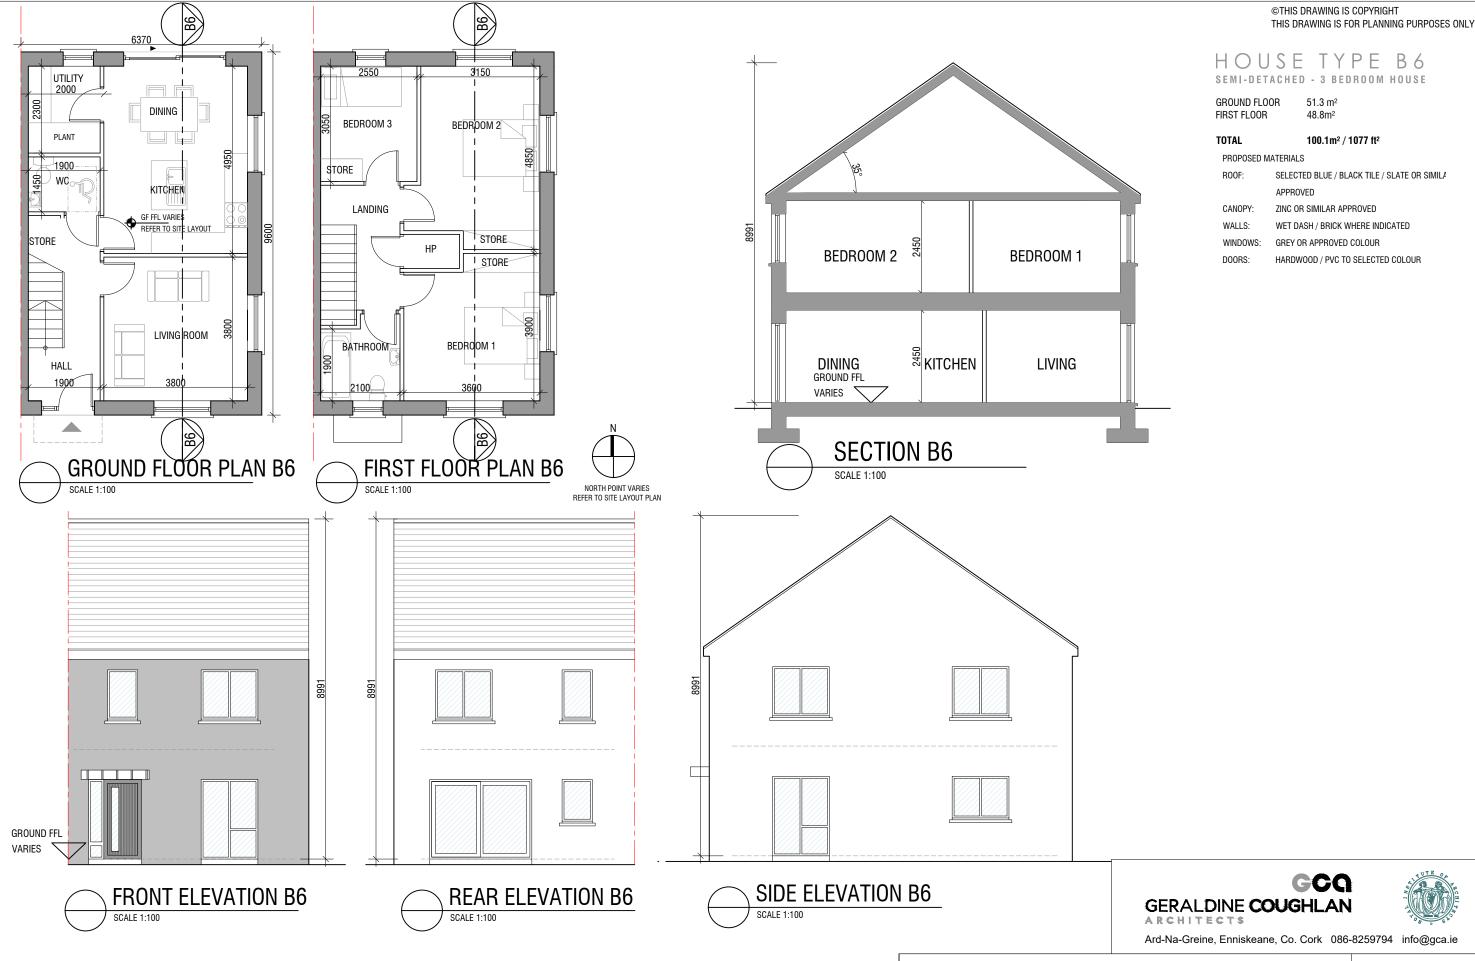

PRIVATE AMENITY

STORAGE

AGGREGATE

QUALITY HOUSING OVERVIEW

MIN LIVING ROOM | WIDTH OF LIVING | AGGREGATE KILID | DOUBLE BEDROOM | SINGLE BEDROOM |

37.6 SQ/M

MIN FLOOR AREA

92 SQ/M

3 BED/5P 2 STORE

HOUSE

B6 HOUSE TYPE
ACHIEVED
ACHIEVED
B6 HOUSE
B6 HOUSE TYPE
ACHIEVED
HOUSE

PROJECT:	RESIDENTIA	L DEVELO	OPMENT, B	ROOM	ISFIELD, N	MIDLETON	JOB NO:	24026
DRAWING:	HOUSE TYPE -PLANS,ELEV	B6 ATIONS 8	SECTION	ER	CLIENT:	ccc	DRAWING	
SERIES:	PLANNING	SCALE:	1:100	А3	DATE:	17/09/2024	В	6



QUALITY HOUSING OVERVIEW RIVATE AMENITY MIN FLOOR AREA STORAGE 16.5 SQ/M 4.95 M 32.2 SQ/M 2.85 M REFER TO SITE ACHIEVED LAYOUT

HOUSE TYPE TERRACED - 2 BEDROOM HOUSE


GROUND FLOOR 43.8 m² FIRST FLOOR 41.3m²

TOTAL 85.1 m² / 916 ft²

PROPOSED MATERIALS

ROOF: SELECTED BLUE / BLACK TILE / SLATE OR SIMILAR


ZINC OR SIMILAR APPROVED CANOPY: WET DASH / BRICK WHERE INDICATED WINDOWS: GREY OR APPROVED COLOUR

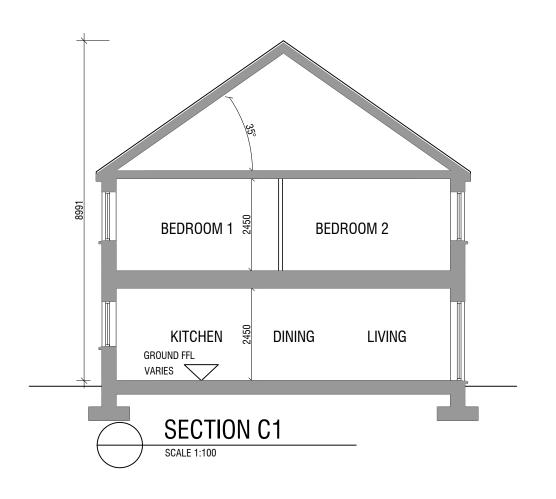








PROJECT:	RESIDENTIA	JOB NO:	24026					
DRAWING: HOUSE TYPE C1 -PLANS,ELEVATIONS & SECTION					CLIENT:	CCC	DRAWING	
SERIES:	PLANNING	SCALE:	1:100	А3	DATE:	17/09/2024	C	2 1

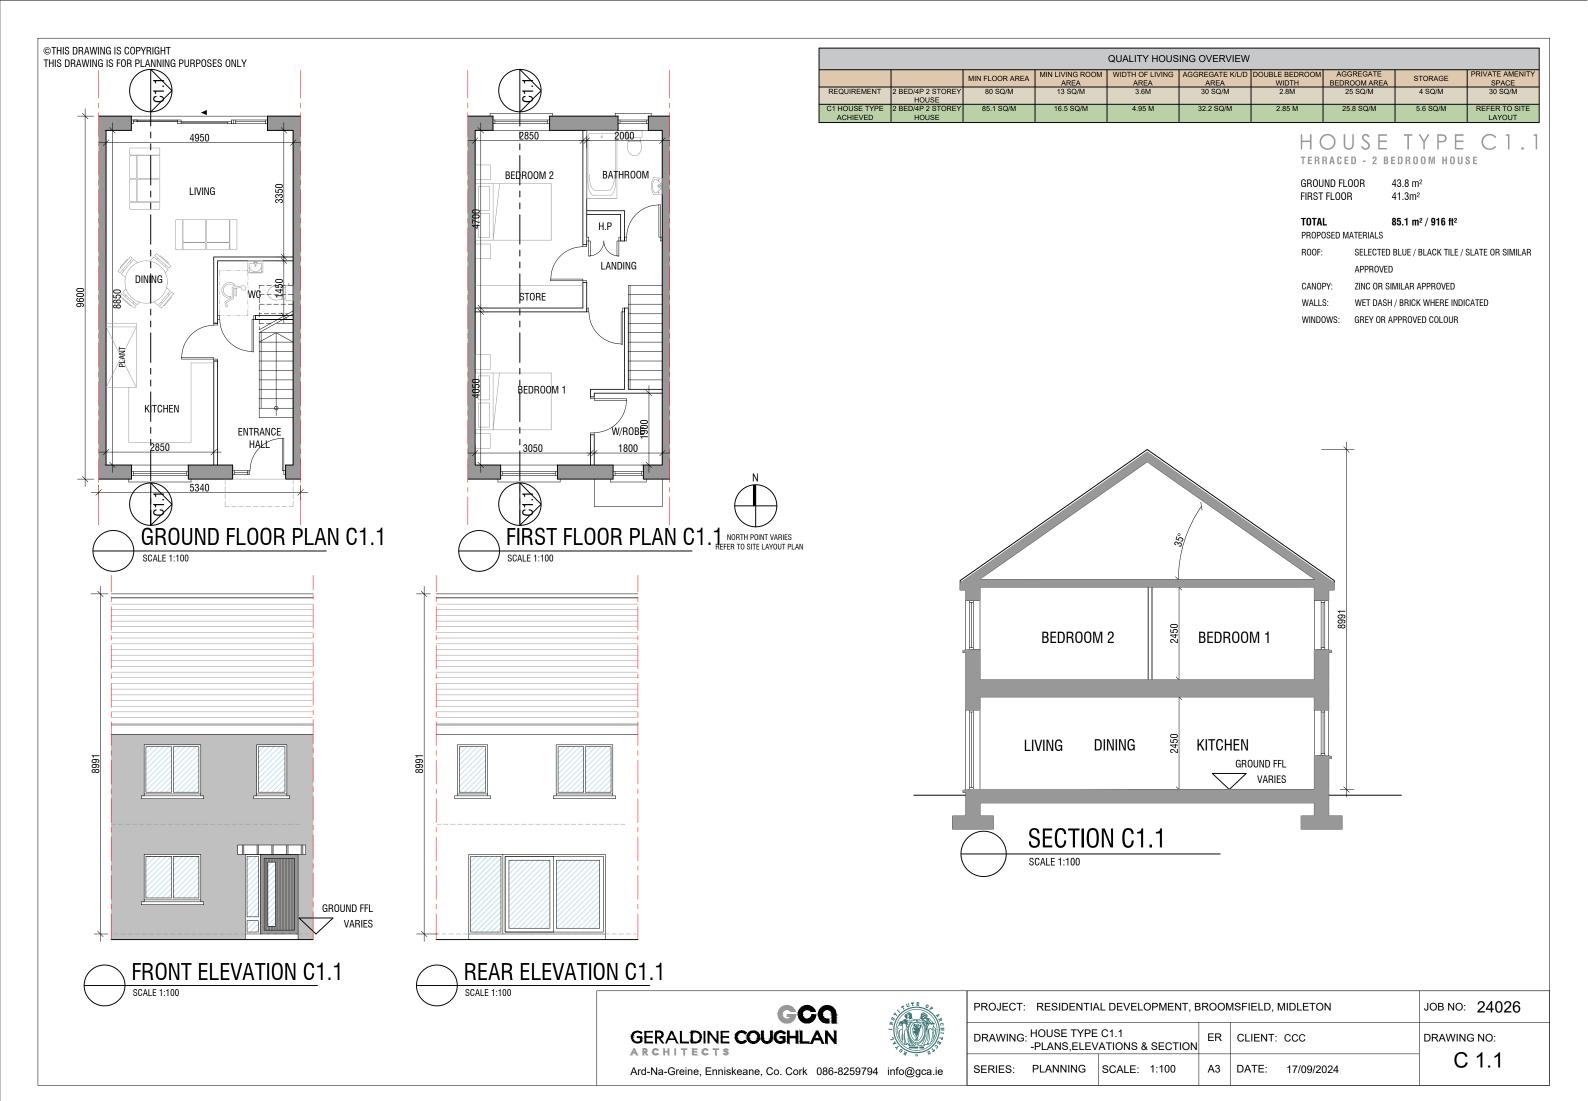

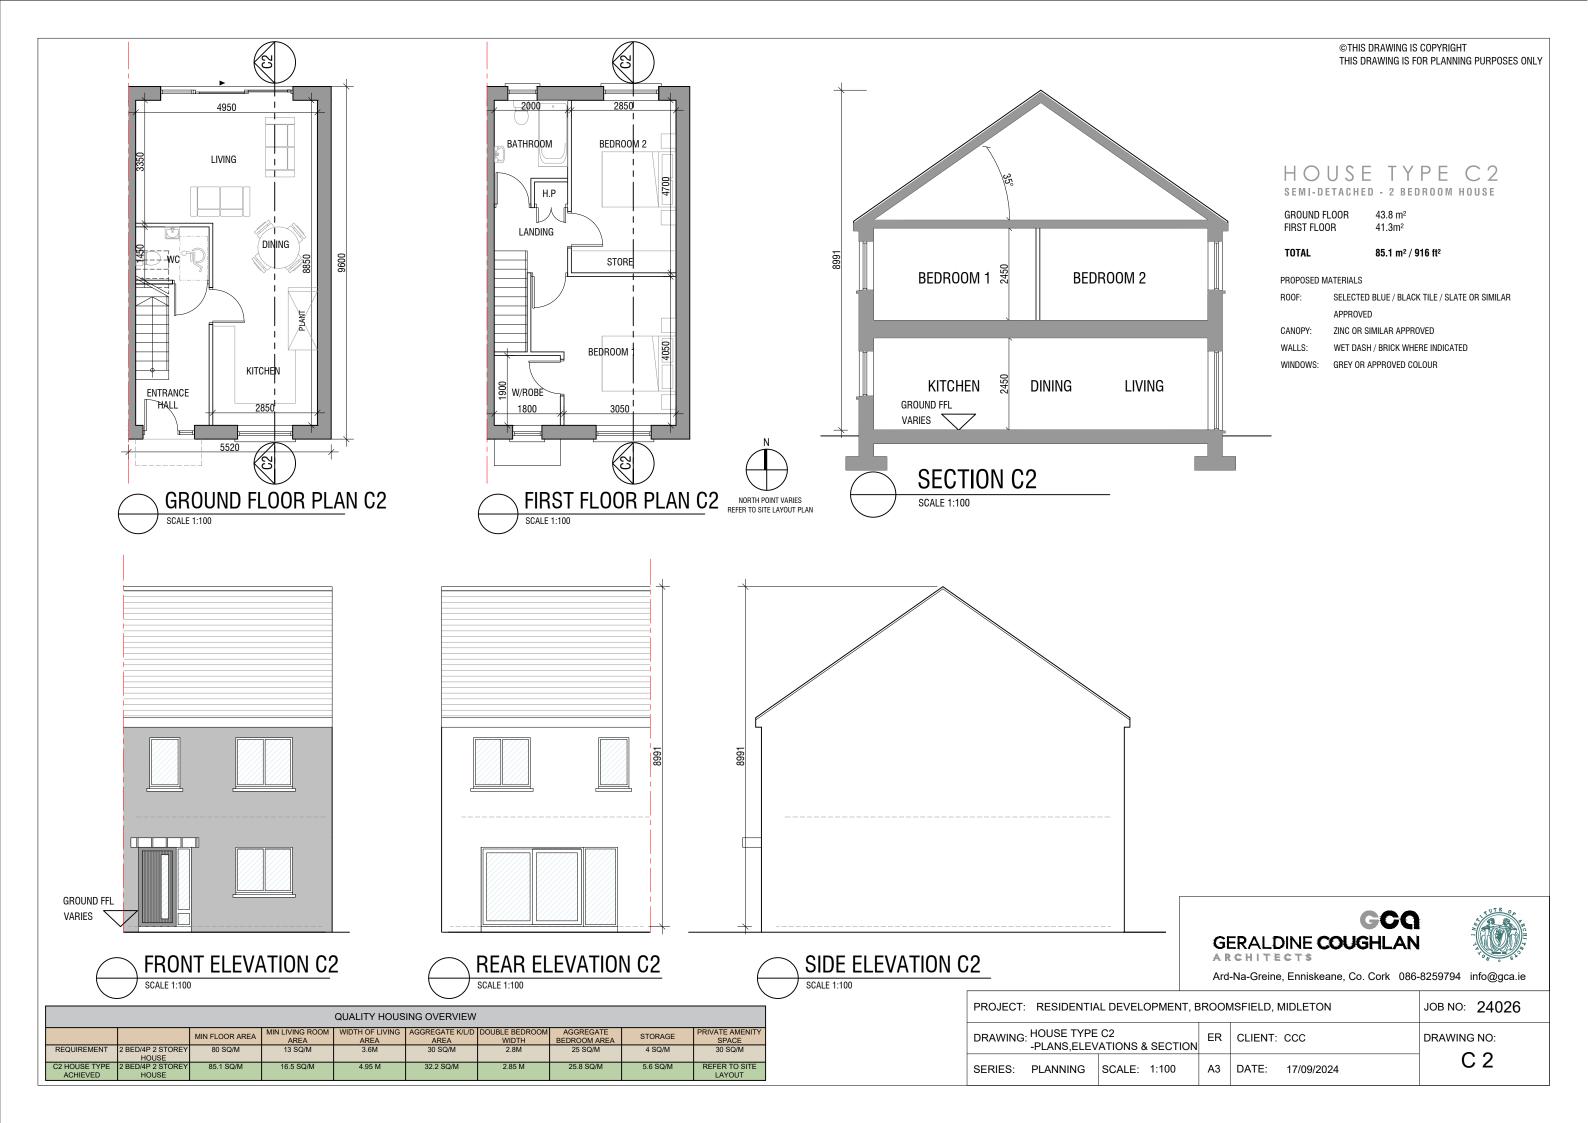

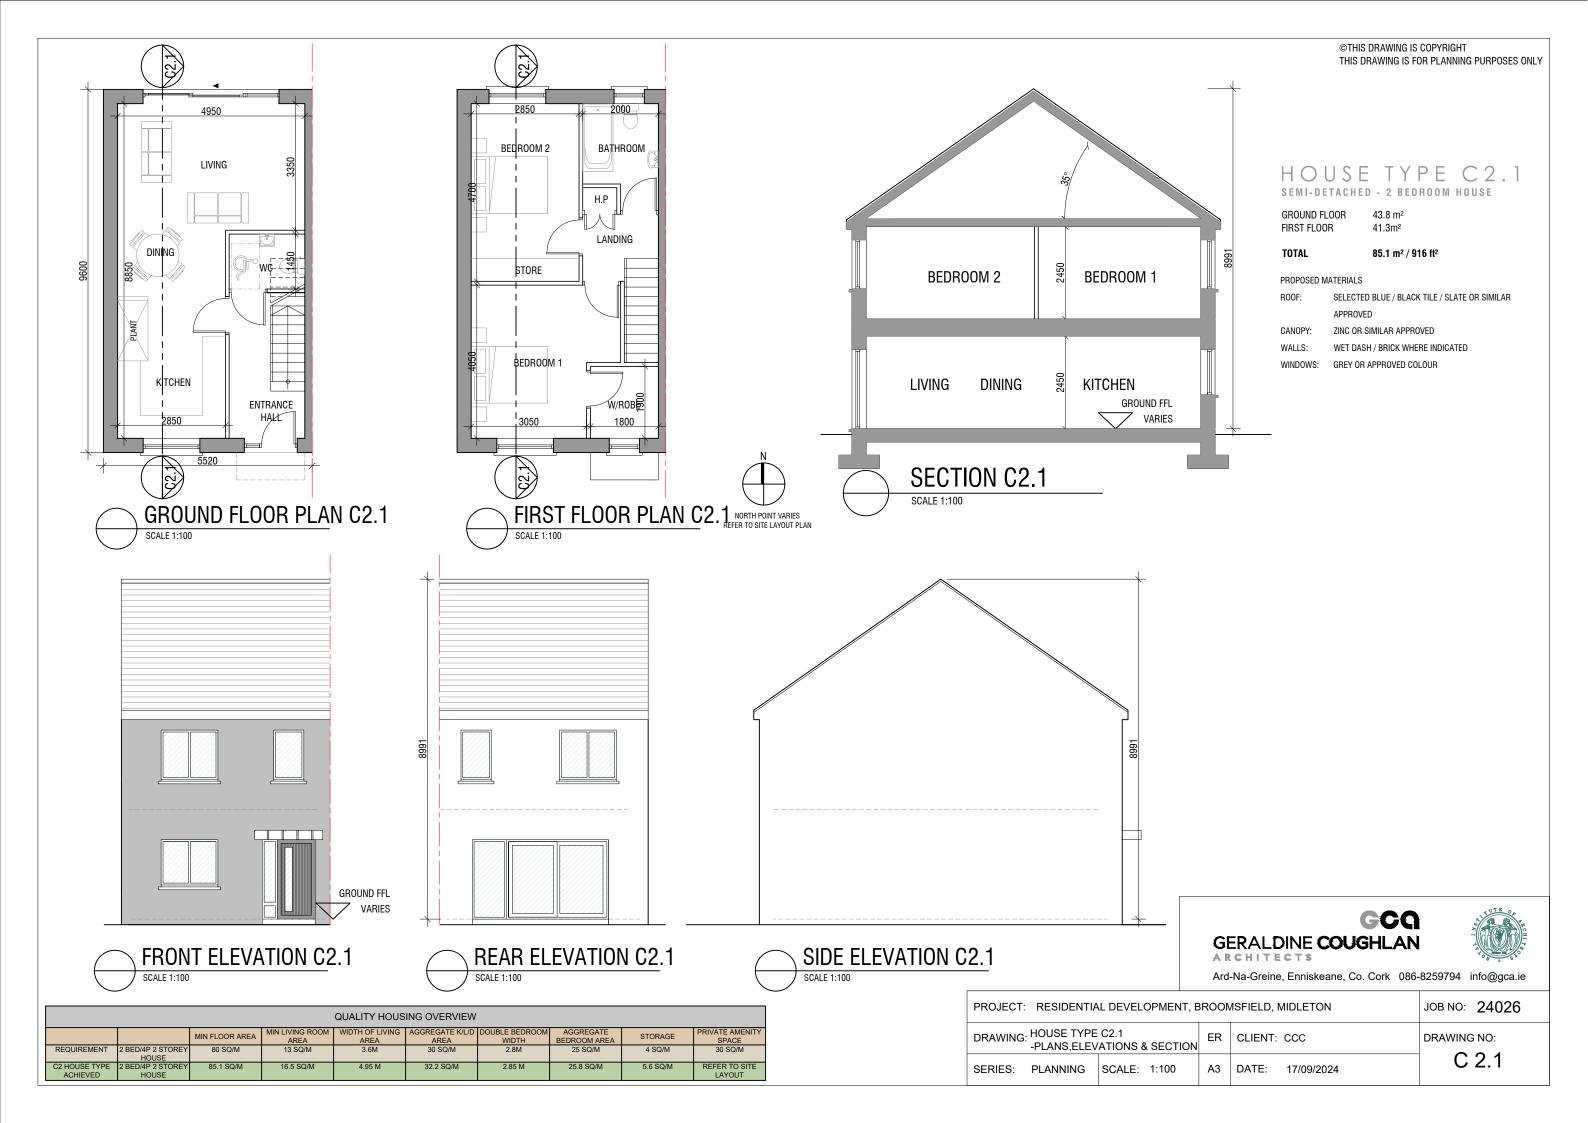

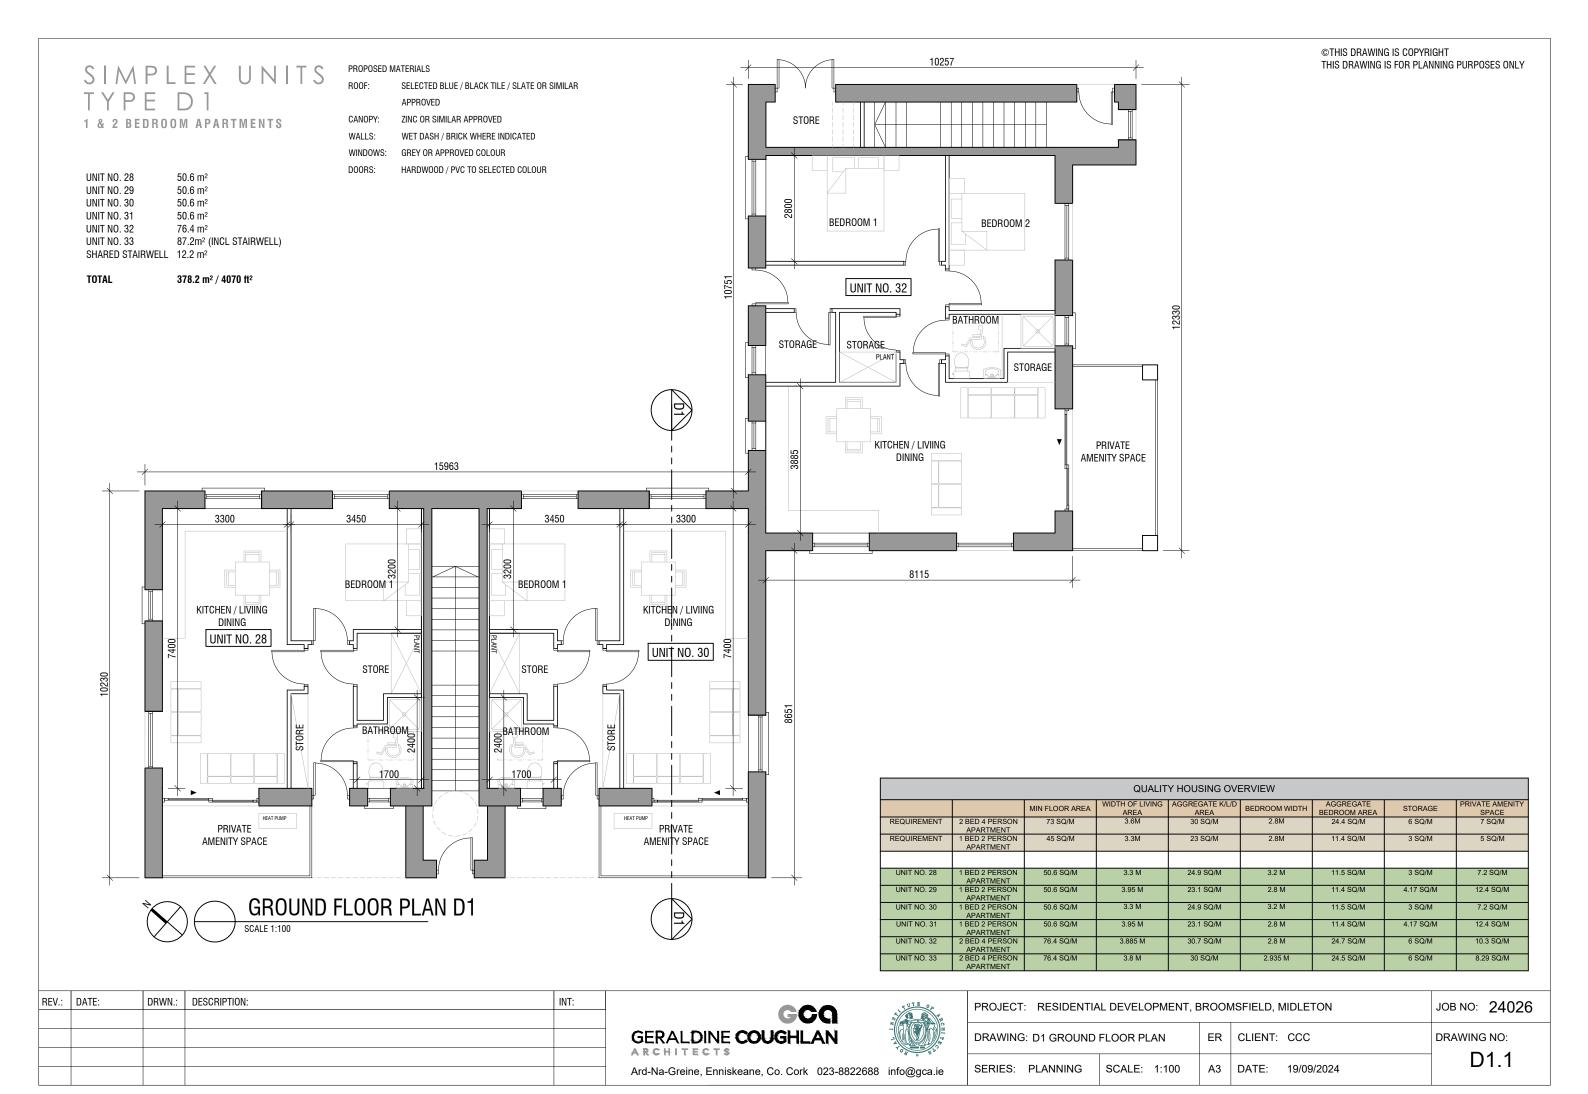

1 & 2 BEDROOM APARTMENTS


UNIT NO. 28 50.6 m² UNIT NO. 29 50.6 m² UNIT NO. 30 50.6 m² UNIT NO. 31 50.6 m² UNIT NO. 32 76.4 m²

UNIT NO. 33 87.2m² (INCL STAIRWELL)

SHARED STAIRWELL 12.2 m²

TOTAL 378.2 m² / 4070 ft² PROPOSED MATERIALS ROOF: SELECTED BLUE / BLACK TILE / SLATE OR SIMILAR

CANOPY: ZINC OR SIMILAR APPROVED WET DASH / BRICK WHERE INDICATED WALLS: WINDOWS: GREY OR APPROVED COLOUR DOORS: HARDWOOD / PVC TO SELECTED COLOUR

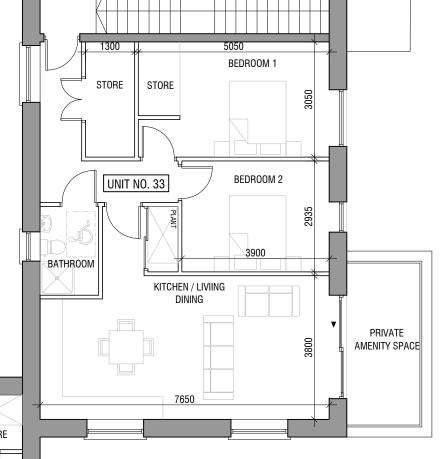

STORE			BATHROOM
UNIT NO. 29	STORE	STORE	UNIT NO. 31
KITCHEN / LIVIING DINING	BEDROOM 1 14	BEDROOM 1	KITCHENI/ LIVIING DINING
3950	2800	2800	3950
PRIVATE AMENITY SPACE			HEAT PUMP PRIVATE AMENITY SPACE

FIRST FLOOR PLAN D1

	QUALITY HOUSING OVERVIEW												
		MIN FLOOR AREA	WIDTH OF LIVING AREA	AGGREGATE K/L/D AREA	BEDROOM WIDTH	AGGREGATE BEDROOM AREA	STORAGE	PRIVATE AMENITY SPACE					
REQUIREMENT	2 BED 4 PERSON APARTMENT	73 SQ/M	3.6M	30 SQ/M	2.8M	24.4 SQ/M	6 SQ/M	7 SQ/M					
REQUIREMENT	1 BED 2 PERSON APARTMENT	45 SQ/M	3.3M	23 SQ/M	2.8M	11.4 SQ/M	3 SQ/M	5 SQ/M					
UNIT NO. 28	1 BED 2 PERSON APARTMENT	50.6 SQ/M	3.3 M	24.9 SQ/M	3.2 M	11.5 SQ/M	3 SQ/M	7.2 SQ/M					
UNIT NO. 29	1 BED 2 PERSON APARTMENT	50.6 SQ/M	3.95 M	23.1 SQ/M	2.8 M	11.4 SQ/M	4.17 SQ/M	12.4 SQ/M					
UNIT NO. 30	1 BED 2 PERSON APARTMENT	50.6 SQ/M	3.3 M	24.9 SQ/M	3.2 M	11.5 SQ/M	3 SQ/M	7.2 SQ/M					
UNIT NO. 31	1 BED 2 PERSON APARTMENT	50.6 SQ/M	3.95 M	23.1 SQ/M	2.8 M	11.4 SQ/M	4.17 SQ/M	12.4 SQ/M					
UNIT NO. 32	2 BED 4 PERSON APARTMENT	76.4 SQ/M	3.885 M	30.7 SQ/M	2.8 M	24.7 SQ/M	6 SQ/M	10.3 SQ/M					
UNIT NO. 33	2 BED 4 PERSON APARTMENT	76.4 SQ/M	3.8 M	30 SQ/M	2.935 M	24.5 SQ/M	6 SQ/M	8.29 SQ/M					

REV.:	DATE:	DRWN.:	DESCRIPTION:	INT:

GCQ **GERALDINE COUGHLAN**



PROJECT:	JOB NO: 24026						
DRAWING:	D1 FIRST FLC	OR PLAN		ER	CLIENT:	CCC	DRAWING NO:
SERIES:	PLANNING	SCALE:	1:100	А3	DATE:	19/09/2024	D1.2



FRONT ELEVATION SCALE 1:100

SIMPLEX UNITS TYPE D1

1 & 2 BEDROOM APARTMENTS

UNIT NO. 28 50.6 m² UNIT NO. 29 50.6 m² UNIT NO. 30 50.6 m² UNIT NO. 31 50.6 m² UNIT NO. 32 76.4 m²

87.2m² (INCL STAIRWELL) UNIT NO. 33

SHARED STAIRWELL 12.2 m²

TOTAL 378.2 m² / 4070 ft²

PROPOSED MATERIALS

ROOF: SELECTED BLUE / BLACK TILE / SLATE OR SIMILAR

APPROVED

CANOPY: ZINC OR SIMILAR APPROVED WALLS: WET DASH / BRICK WHERE INDICATED WINDOWS: GREY OR APPROVED COLOUR DOORS: HARDWOOD / PVC TO SELECTED COLOUR



REV.:	DATE:	DRWN.:	DESCRIPTION:	INT:

GCQ
GERALDINE COUGHLAN
ARCHITECTS

GC	i O	
GERALDINE COUGHLA	AN	
Ard-Na-Greine, Enniskeane, Co. Cork	023-8822688	info@gca.ie

PROJECT:	ROJECT: RESIDENTIAL DEVELOPMENT, BROOMSFIELD, MIDLETON							
DRAWING: D1 ELEVATIONS				ER	CLIENT:	CCC	DRAWING NO:	
SERIES:	PLANNING	SCALE:	1:100	А3	DATE:	19/09/2024	D1.3	



1 & 2 BEDROOM APARTMENTS

UNIT NO. 28 50.6 m² UNIT NO. 29 50.6 m² UNIT NO. 30 50.6 m² UNIT NO. 31 50.6 m² UNIT NO. 32 76.4 m²

UNIT NO. 33 87.2m² (INCL STAIRWELL)

SHARED STAIRWELL 12.2 m²


TOTAL 378.2 m² / 4070 ft² PROPOSED MATERIALS

ROOF: SELECTED BLUE / BLACK TILE / SLATE OR SIMILAR

CANOPY: ZINC OR SIMILAR APPROVED WET DASH / BRICK WHERE INDICATED WALLS: GREY OR APPROVED COLOUR WINDOWS:

DOORS: HARDWOOD / PVC TO SELECTED COLOUR



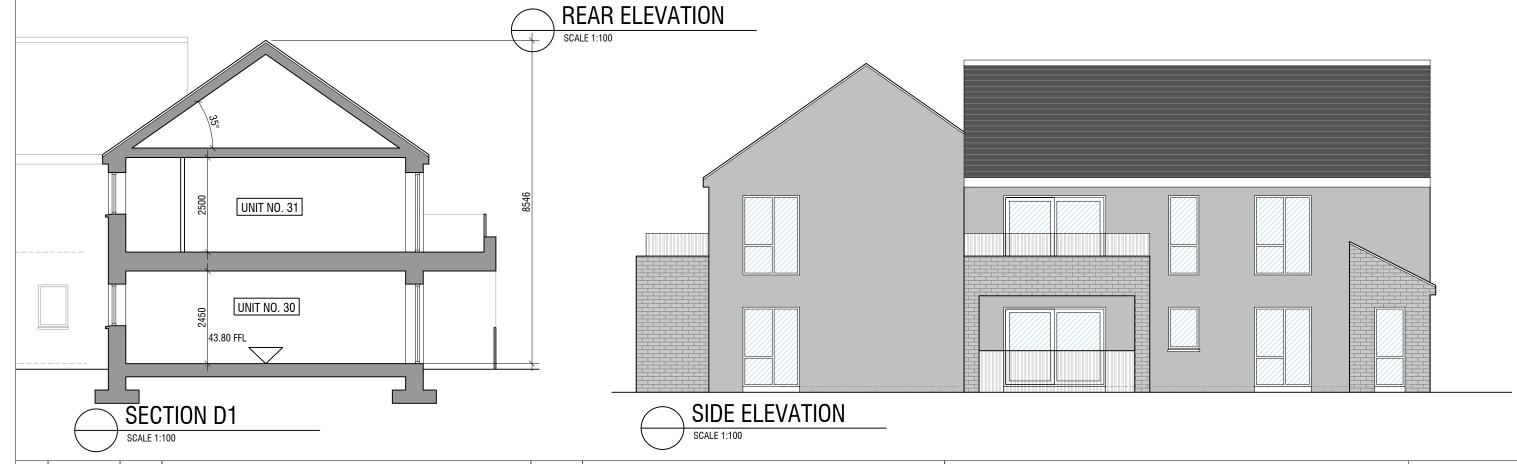

REV.: DATE: DRWN.: DESCRIPTION: INT:





PROJECT: RESIDENTIA	JOB NO: 24026			
DRAWING: D1 ELEVATION	ONS & SECTION	ER	CLIENT: CCC	DRAWING NO:
SERIES: PLANNING	SCALE: 1:100	A3	DATE: 19/09/2024	D1.4

SIMPLEX UNITS PROPOSED MATERIALS ROOF: SELECTED TYPE D2

1 & 2 BEDROOM APARTMENTS

UNIT NO. 34 70 m² UNIT NO. 35 70 m² UNIT NO. 36 52 m² UNIT NO. 37 52 m² UNIT NO. 38 52 m² UNIT NO. 39 52 m² UNIT NO. 40 52.5 m² UNIT NO. 41 52.5 m²

TOTAL $453\;m^2\,/\;4876\;ft^2$

SELECTED BLUE / BLACK TILE / SLATE OR SIMILAR

APPROVED

CANOPY: ZINC OR SIMILAR APPROVED

WALLS: WET DASH / BRICK WHERE INDICATED

WINDOWS: GREY OR APPROVED COLOUR HARDWOOD / PVC TO SELECTED COLOUR

			QUALIT	Y HOUSING OVI	ERVIEW			
		MIN FLOOR AREA	WIDTH OF LIVING AREA	AGGREGATE K/L/D AREA	BEDROOM WIDTH	AGGREGATE BEDROOM AREA	STORAGE	PRIVATE AMENITY SPACE
REQUIREMENT	2 BED 3 PERSON APARTMENT	63 SQ/M	3.6M	28 SQ/M	2.8M	20.1 SQ/M	5 SQ/M	6 SQ/M
REQUIREMENT	1 BED 2 PERSON APARTMENT	45 SQ/M	3.3M	23 SQ/M	2.8M	11.4 SQ/M	3 SQ/M	5 SQ/M
UNIT NO. 34	2 BED 3 PERSON	63 m²	3.65m	29.2 m²	3.0 m	20.2 m²	5.3 m²	8.6 m ²
01411 140: 04	APARTMENT	00 III	0.00111	20.2 111	0.0 111	20.2 111	0.0111	0.0111
UNIT NO. 35	2 BED 3 PERSON APARTMENT	63 m²	3.65m	29.2 m²	3.13 m	20.3 m ²	5.3 m ²	9.5 m²
UNIT NO. 36	1 BED 2 PERSON APARTMENT	52 m²	3.3m	24 m²	2.85 m	11.8 m²	3.2 m ²	6.2 m²
UNIT NO. 37	1 BED 2 PERSON APARTMENT	52 m²	3.615m	25.2 m ²	2.85 m	11.8 m²	3.4 m²	6.4 m²
UNIT NO. 38	1 BED 2 PERSON APARTMENT	52 m²	3.3m	24 m²	2.85 m	11.8 m²	3.2 m ²	6.2 m ²
UNIT NO. 39	1 BED 2 PERSON APARTMENT	52 m²	3.615m	25.2 m ²	2.85 m	11.8 m²	3.4 m²	6.4 m²
UNIT NO. 40	1 BED 2 PERSON APARTMENT	52.6 m²	3.3m	24.6 m²	2.85 m	11.8 m²	3.2 m ²	6.2 m²
UNIT NO. 41	1 BED 2 PERSON	52.6 m ²	4.765m	24.6 m ²	3.3 m	13.8 m ²	3.5 m ²	6.3 m ²

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	11390		24540	+
	YARD HEAT PUMP	YARD	I YARD	YARD
8755	KITCHEN / LIVIING DINING UNIT NO. 34 BEDROOM 2 BEDROOM 2 3050 3650	STORE PLANT BATHROOM 2150 KITCHEN / LIVIING DINING 2850 3300	STORE PLANT BATHROOM 2150 WITCHEN / LIVIING DINING 1500mm 2850 3300	STORE PLANT BATHROOM 2150 KITCHEN / LIVIING DINING 2850 3300 3300
	PRIVATE OPEN SPACE 4640 6393	PRIVATE OPEN SPACE	PRIVATE OPEN SPACE 4290	PRIVATE OPEN SPACE 4210 4230
	4040 0393	4267 4290	3910 4290	4210 4230
	GROUND FLOOR PLAN D2 SCALE 1:100			

REV.:	DATE:	DRWN.:	DESCRIPTION:	INT:

	GCQ
GERALDINE	COUGHLAN
ARCHITECTS	



PROJECT: RESIDE	JOB NO: 24026			
DRAWING: D2 GROU	ND FLOOR PLAN	ER	CLIENT: CCC	DRAWING NO:
SERIES: PLANNIN	SCALE: 1:100	A3	DATE: 19/09/2024	D2.1

SIMPLEX UNITS

453 m² / 4876 ft²

1 & 2 BEDROOM APARTMENTS

UNIT NO. 34 70 m² UNIT NO. 35 70 m² UNIT NO. 36 52 m² UNIT NO. 37 52 m² UNIT NO. 38 52 m² UNIT NO. 39 52 m² UNIT NO. 40 52.5 m² UNIT NO. 41 52.5 m²

TOTAL


PROPOSED MATERIALS

SELECTED BLUE / BLACK TILE / SLATE OR SIMILAR

ZINC OR SIMILAR APPROVED CANOPY: WALLS: WET DASH / BRICK WHERE INDICATED WINDOWS: GREY OR APPROVED COLOUR HARDWOOD / PVC TO SELECTED COLOUR DOORS:

QUALITY HOUSING OVERVIEW									
		MIN FLOOR AREA	WIDTH OF LIVING AREA	AGGREGATE K/L/D AREA	BEDROOM WIDTH	AGGREGATE BEDROOM AREA	STORAGE	PRIVATE AMENITY SPACE	
REQUIREMENT	2 BED 3 PERSON APARTMENT	63 SQ/M	3.6M	28 SQ/M	2.8M	20.1 SQ/M	5 SQ/M	6 SQ/M	
REQUIREMENT	1 BED 2 PERSON APARTMENT	45 SQ/M	3.3M	23 SQ/M	2.8M	11.4 SQ/M	3 SQ/M	5 SQ/M	
UNIT NO. 34	2 BED 3 PERSON APARTMENT	63 m²	3.65m	29.2 m²	3.0 m	20.2 m ²	5.3 m ²	8.6 m ²	
UNIT NO. 35	2 BED 3 PERSON APARTMENT	63 m²	3.65m	29.2 m²	3.13 m	20.3 m²	5.3 m ²	9.5 m²	
UNIT NO. 36	1 BED 2 PERSON APARTMENT	52 m²	3.3m	24 m²	2.85 m	11.8 m²	3.2 m ²	6.2 m ²	
UNIT NO. 37	1 BED 2 PERSON APARTMENT	52 m²	3.615m	25.2 m²	2.85 m	11.8 m²	3.4 m ²	6.4 m ²	
UNIT NO. 38	1 BED 2 PERSON APARTMENT	52 m²	3.3m	24 m²	2.85 m	11.8 m²	3.2 m ²	6.2 m ²	
UNIT NO. 39	1 BED 2 PERSON APARTMENT	52 m²	3.615m	25.2 m²	2.85 m	11.8 m²	3.4 m²	6.4 m²	
UNIT NO. 40	1 BED 2 PERSON APARTMENT	52.6 m²	3.3m	24.6 m²	2.85 m	11.8 m²	3.2 m ²	6.2 m²	
UNIT NO. 41	1 BED 2 PERSON	52.6 m ²	4.765m	24.6 m ²	3.3 m	13.8 m ²	3.5 m ²	6.3 m ²	

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REV.:	DATE:	DRWN.:	DESCRIPTION:	INT:

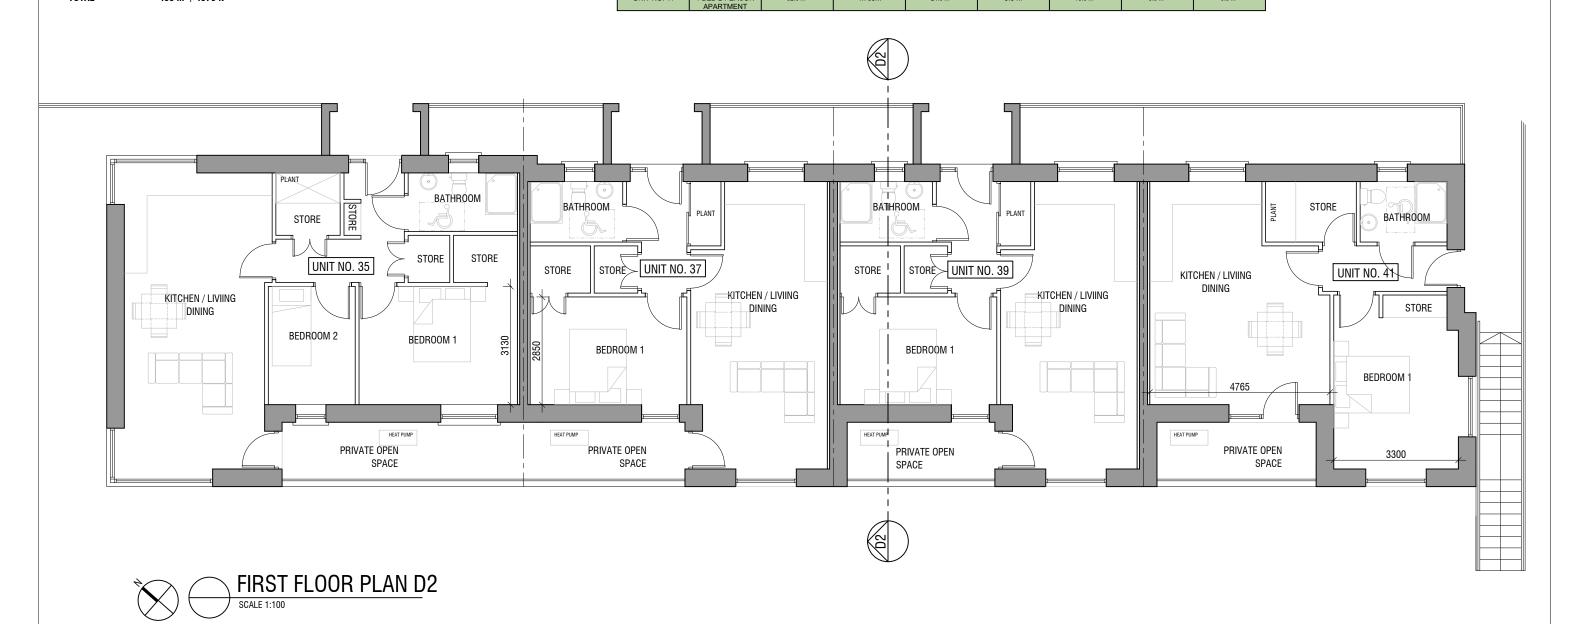



PROJECT: RESIDENTIAL DEVELOPMENT, BROOMSFIELD, MIDLETON							JOB NO: 24026	Ì
DRAWING: D2 FIRST FLOOR PLAN				ER	CLIENT:	ccc	DRAWING NO:	Ì
SERIES:	PLANNING	SCALE:	1:100	А3	DATE:	19/09/2024	D2.2	





NORTH EAST ELEVATION

SIMPLEX UNITS

453 m² / 4876 ft²

1 & 2 BEDROOM APARTMENTS

UNIT NO. 34 UNIT NO. 35 70 m² UNIT NO. 36 52 m² UNIT NO. 37 52 m² UNIT NO. 38 52 m² UNIT NO. 39 52 m² UNIT NO. 40 52.5 m² UNIT NO. 41 52.5 m²

TOTAL

PROPOSED MATERIALS

ROOF: SELECTED BLUE / BLACK TILE / SLATE OR SIMILAR

APPROVED

ZINC OR SIMILAR APPROVED CANOPY: WALLS: WET DASH / BRICK WHERE INDICATED WINDOWS: GREY OR APPROVED COLOUR HARDWOOD / PVC TO SELECTED COLOUR

> GCQ GERALDINE COUGHLAN



PROJECT:	JOB NO: 24026						
DRAWING: D2 ELEVATIONS				ER	CLIENT:	CCC	DRAWING NO:
SERIES:	PLANNING	SCALE:	1:100	А3	DATE:	19/09/2024	D2.3

1 & 2 BEDROOM APARTMENTS

UNIT NO. 34 70 m² UNIT NO. 35 70 m² UNIT NO. 36 52 m² UNIT NO. 37 52 m² UNIT NO. 38 52 m² 52 m² UNIT NO. 39 UNIT NO. 40 52.5 m² UNIT NO. 41 52.5 m²

453 m² / 4876 ft² TOTAL

PROPOSED MATERIALS

SELECTED BLUE / BLACK TILE / SLATE OR SIMILAR

APPROVED

CANOPY: ZINC OR SIMILAR APPROVED WALLS: WET DASH / BRICK WHERE INDICATED WINDOWS: GREY OR APPROVED COLOUR DOORS: HARDWOOD / PVC TO SELECTED COLOUR 있 UNIT NO. 39 UNIT NO. 38







REV.:	DATE:	DRWN.:	DESCRIPTION:	INT:

									GCQ	
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PROJECT	JOB NO: 24026						
DRAWING	: D2 ELEVATIC	NS & SEC	TION	ER	CLIENT:	CCC	DRAWING NO:
SERIES:	PLANNING	SCALE:	1:100	А3	DATE:	19/09/2024	D2.4

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2 BEDROOM APARTMENTS

UNIT NO. 42 76.7 m² UNIT NO. 43 76.7 m² UNIT NO. 44 76.3 m²

UNIT NO. 45 89.2m² (INCL STAIRWELL)

TOTAL 318.9 m² / 3432 ft²

PROPOSED MATERIALS

ROOF: SELECTED BLUE / BLACK TILE / SLATE OR SIMILAR


APPROVED

CANOPY: ZINC OR SIMILAR APPROVED

WALLS: WET DASH / BRICK WHERE INDICATED

WINDOWS: GREY OR APPROVED COLOUR

DOORS: HARDWOOD / PVC TO SELECTED COLOUR

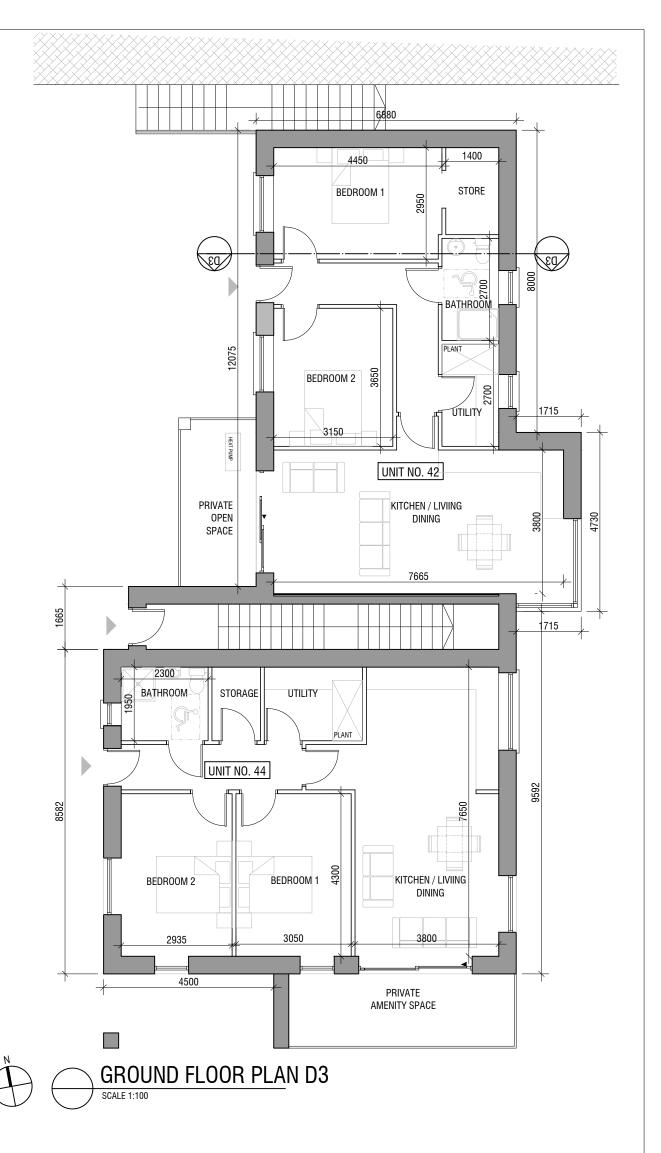

	QUALITY HOUSING OVERVIEW											
		MIN FLOOR AREA	WIDTH OF LIVING AREA	AGGREGATE K/L/D AREA	BEDROOM WIDTH	AGGREGATE BEDROOM AREA	STORAGE	PRIVATE AMENITY SPACE				
REQUIREMENT	2 BED 4 PERSON APARTMENT	73 SQ/M	3.6M	30 SQ/M	2.8M	24.4 SQ/M	6 SQ/M	7 SQ/M				
UNIT NO. 42	2 BED 4 PERSON APARTMENT	76.7 m²	3.8m	30.1 m²	2.95 m	24.5 m²	6.0 m²	8.7 m²				
UNIT NO. 43	2 BED 4 PERSON APARTMENT	76.7 m²	3.8m	30.2 m²	3.15 m	25.3 m²	6.0 m²	10.1 m ²				
UNIT NO. 44	2 BED 4 PERSON APARTMENT	76.3 m²	3.8m	30.0 m²	2.935 m	25.7 m²	6.2 m ²	11.4 m²				
UNIT NO. 45	2 BED 4 PERSON APARTMENT	76.3 m²	3.8m	30.0 m ²	2.935 m	24.5 m²	6.6 m²	7.0 m ²				



Ard-Na-Greine, Enniskeane, Co. Cork 023-8822688 info@gca.ie

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PROJECT:	JOB NO: 24026						
DRAWING	: D3 GROUND	FLOOR PL	AN	ER	CLIENT:	CCC	DRAWING NO:
SERIES:	PLANNING	SCALE:	1:100	А3	DATE:	19/09/2024	D3.1

2 BEDROOM APARTMENTS

UNIT NO. 42 76.7 m² UNIT NO. 43 76.7 m² UNIT NO. 44 76.3 m²

89.2m² (INCL STAIRWELL) UNIT NO. 45


TOTAL 318.9 m² / 3432 ft²

PROPOSED MATERIALS

ROOF: SELECTED BLUE / BLACK TILE / SLATE OR SIMILAR

APPROVED

ZINC OR SIMILAR APPROVED CANOPY: WET DASH / BRICK WHERE INDICATED WALLS: WINDOWS: GREY OR APPROVED COLOUR HARDWOOD / PVC TO SELECTED COLOUR DOORS:

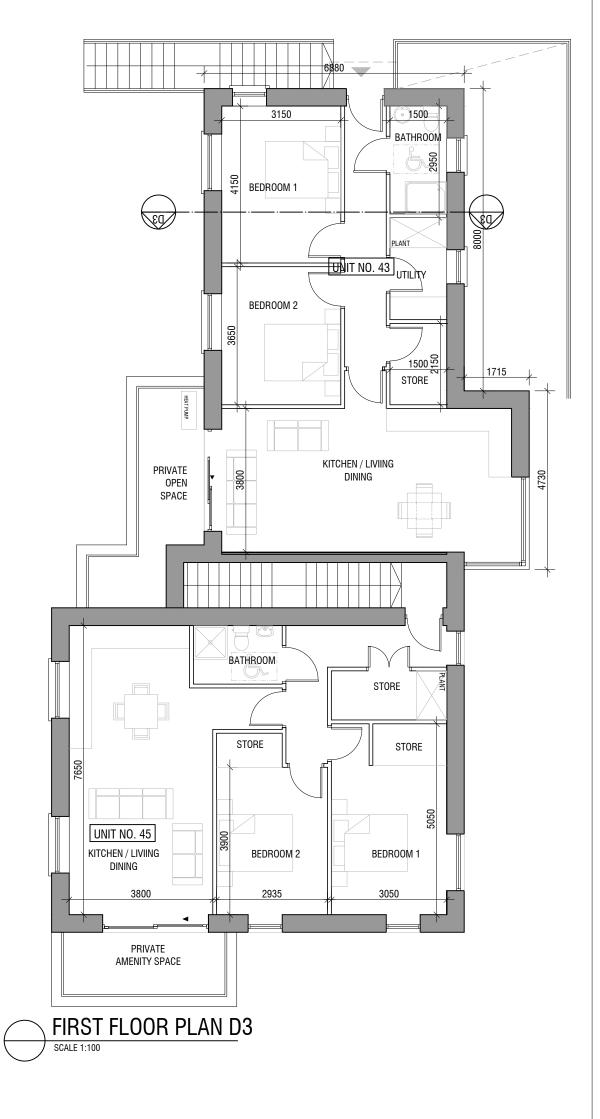

QUALITY HOUSING OVERVIEW											
		MIN FLOOR AREA	WIDTH OF LIVING AREA	AGGREGATE K/L/D AREA	BEDROOM WIDTH	AGGREGATE BEDROOM AREA	STORAGE	PRIVATE AMENITY SPACE			
REQUIREMENT	2 BED 4 PERSON APARTMENT	73 SQ/M	3.6M	30 SQ/M	2.8M	24.4 SQ/M	6 SQ/M	7 SQ/M			
UNIT NO. 42	2 BED 4 PERSON APARTMENT	76.7 m²	3.8m	30.1 m²	2.95 m	24.5 m²	6.0 m ²	8.7 m²			
UNIT NO. 43	2 BED 4 PERSON APARTMENT	76.7 m²	3.8m	30.2 m²	3.15 m	25.3 m²	6.0 m ²	10.1 m²			
UNIT NO. 44	2 BED 4 PERSON APARTMENT	76.3 m²	3.8m	30.0 m²	2.935 m	25.7 m²	6.2 m ²	11.4 m²			
UNIT NO. 45	2 BED 4 PERSON APARTMENT	76.3 m²	3.8m	30.0 m²	2.935 m	24.5 m²	6.6 m ²	7.0 m²			





PROJECT: RESIDENTIA	JOB NO: 24026			
DRAWING: D3 FIRST FLO	OOR PLAN	ER	CLIENT: CCC	DRAWING NO:
SERIES: DESIGN	SCALE: 1:100	А3	DATE: 19/09/2024	D3.2

2 BEDROOM APARTMENTS

UNIT NO. 42 76.7 m² UNIT NO. 43 76.7 m² UNIT NO. 44 76.3 m²

89.2m2 (INCL STAIRWELL) UNIT NO. 45

TOTAL 318.9 m² / 3432 ft²



APPROVED CANOPY: ZINC OR SIMILAR APPROVED WALLS: WET DASH / BRICK WHERE INDICATED WINDOWS: GREY OR APPROVED COLOUR

SELECTED BLUE / BLACK TILE / SLATE OR SIMILAR HARDWOOD / PVC TO SELECTED COLOUR 8039

FRONT ELEVATION







REV.:	DATE:	DRWN.:	DESCRIPTION:	INT:

GCQ GERALDINE COUGHLAN



PROJECT:	RESIDENTIA	L DEVELO	JOB NO: 24026					
DRAWING: D3 ELEVATIONS & SECTION				ER	CLIENT:	CCC	DRAWING NO:	
SERIES:	PLANNING	SCALE:	1:100	А3	DATE:	19/09/2024	D3.3	

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2 BEDROOM APARTMENTS

UNIT NO. 42 UNIT NO. 43 UNIT NO. 44

76.3 m² 89.2m2 (INCL STAIRWELL) UNIT NO. 45

76.7 m²

76.7 m²

TOTAL 318.9 m² / 3432 ft² PROPOSED MATERIALS


SELECTED BLUE / BLACK TILE / SLATE OR SIMILAR


APPROVED

CANOPY: ZINC OR SIMILAR APPROVED

WALLS: WET DASH / BRICK WHERE INDICATED

WINDOWS: GREY OR APPROVED COLOUR HARDWOOD / PVC TO SELECTED COLOUR

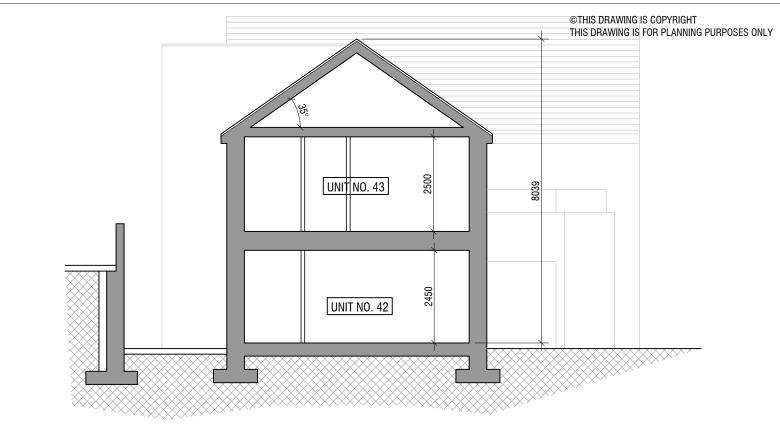

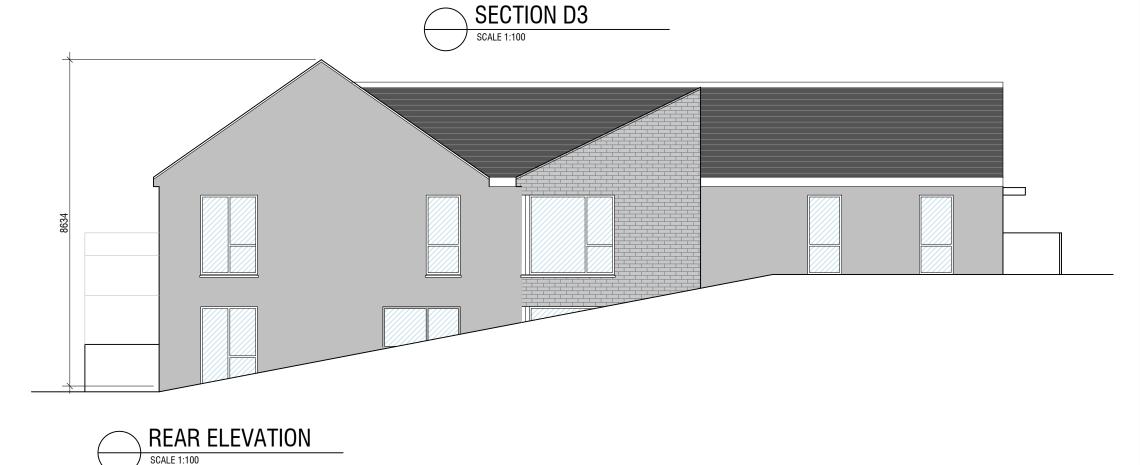

REV.:	DATE:	DRWN.:	DESCRIPTION:	INT:

	GCQ
GERALDINE COU	GHLAN
ARCHITECTS	



	PROJECT: RESIDENTIAL DEVELOPMENT, BROOMSFIELD, MIDLETON							JOB NO: 24026
DRAWING: D3 ELEVATIONS & SECTION				ER	CLIENT:	CCC	DRAWING NO:	
	SERIES:	PLANNING	SCALE:	1:100	А3	DATE:	19/09/2024	D3.4